PROJECT INFORMATION

SCOPE OF WORK:

REMOVE/RELOCATE/INSTALL WIRELESS COMMUNICATIONS ANTENNAS, RRH'S, AND ASSOCIATED SUPPORT EQUIPMENT ON EXISTING ANTENNA MOUNT. INSTALL ASSOCIATED SUPPORT EQUIPMENT AT GROUND LEVEL AND ON EXISTING LTE RACK IN AN EXISTING EQUIPMENT SHELTER. REMOVE/RE-ROUTE/INSTALL ALL NECESSARY COAXIAL CABLES, JUMPERS, FIBER AND DC CABLES ROUTED FROM EQUIPMENT SHELTER ON GROUND LEVEL TO TOP OF TOWER.

SITE ADDRESS:

FA#

700 HOLIDAY TRAILS LANE CHARLOTTESVILLE, VA 22903

10068640

NEW MOUNT DETAIL

GROUNDING NOTES & DETAILS

DC PANEL SCHEDULE & ELECTRICAL NOTES

FAX: (703) 671-6300

POWER CALCULATION SHEET

S-1

E-2

E-3

LATITUDE: N 38" 1' 22.11636"

LONGITUDE: W 78° 33' 28.19988' JURISDICTION: ALBEMARLE COUNTY

PARCEL ID: 07500-00-00-04700 HS1-HOMESITE 1

ZONING:

GROUND ELEVATION: TOWER TYPE: MONOPOLE NAME OF APPLICANT: AT&T

4801 COX RD GLEN ALEN, VA 23060

VERIZON

TOWER OWNER: PROPERTY OWNER:

VERIZON COMMUNICATIONS

140 WEST STREET NEW YORK, NEW YORK 10007

JACOBS



FA #: 10068640

LTE 2C/3C/4C - ANTENNA & RRU ADD



FOR MORE INFORMATION CONTACT THE STATE CORPORATION COMMISSION DIVISION OF UTILITY AND RAILROAD SAFETY

VIRGINIA UTILITY PROTECTION SERVICE, INC. CALL BEFORE YOU DIG: 811 OR 1-800-552-7001

THE DESIGN SHO	OWN IN THESE DRAWINGS IS BASED ON INFORMATION GATHEREI	D FROM THE AT&T RFDS VERSION 2.00 UPDATED	10/22/2019
	UTILITY INFOR	RMATION	
POWER: TELCO:	DOMINION VA POWER CENTURYLINK	1-866-366-4357 1-888-669-3608	
	DRAWING INDEX		REV GR
T-1	TITLE SHEET		2 1 H
GN-1 GN-2	GENERAL NOTES GENERAL NOTES		2 2
A-0 A-1 A-1.1 A-1.2 A-1.3 A-1.4 A-2 A-3 A-4 A-5 A-5.1 A-5.2 A-5.3 A-6 A-6.1 A-7	SITE PLAN COMPOUND PLAN EXISTING & PROPOSED EQUIPMENT LAYOUT GROUND EQUIPMENT DETAILS GROUND EQUIPMENT DETAILS GROUND EQUIPMENT DETAILS TOWER ELEVATION & EQUIPMENT MOUNTING DE EXISTING & PROPOSED ANTENNA PLANS ANTENNA SCHEDULE LTE RET NAMING CONVENTION COLOR CODE CHART TOWER EQUIPMENT DETAILS TOWER EQUIPMENT DETAILS PLUMBING DIAGRAM COLOR CODE CHART ANTENNA CONNECTION DETAILS	TAILS	2 2 2 2 2 2 2 2 2 2 2 2 2 2 2 2 2 2 2

ANY DISCREPANCIES ARE FOUND THE GENERAL CONTRACTOR SHALL NOTIFY ENGINEER IN WRITING. AT NO TIME WILL ANY ADDITIONAL ANTENNAS BE INSTALLED WITHOUT WRITTEN CONSENT FROM TOWER ENGINEER.

DIRECTION:

GET ON I-295 N FROM NUCKOLS RD 1.3 MI. HEAD SOUTH TOWARD N PARK DR. TURN RIGHT ONTO N PARK DR. TURN LEFT ONTO COX RD. TURN RIGHT ONTO NUCKOLS RD. USE THE RIGHT LANE TO MERGE ONTO 1-295 N VIA THE RAMP TO 1-64 W/CHARLOTTESVILLE. MERGE ONTO I-295 N. USE THE RIGHT 2 LANES TO TAKE EXIT 53A TO MERGE ONTO I-64 W TOWARD CHARLOTTESVILLE. TAKE EXIT 118B to merge onto US-29 n toward charlottesville/culpeper. Take the US-29 bus n exit toward charlottesville. Turn left onto US-29 bus s. Continue straight onto fontaine ave extended. Turn right onto reservoir Rd. Slight left onto

VICINITY MAP

HOLIDAY TRAILS LN AND ARRIVE AT DESTINATION.

APPLICABLE BUILDING CODES AND STANDARDS

SUBCONTRACTOR'S WORK SHALL COMPLY WITH ALL APPLICABLE NATIONAL, STATE, AND LOCAL CODES AS ADOPTED BY THE LOCAL AUTHORITY HAVING JURISDICTION (AHJ) FOR THE LOCATION. THE EDITION OF THE AHJ ADOPTED CODES AND STANDARDS IN EFFECT ON THE DATE OF CONTRACT AWARD SHALL GOVERN THE DESIGN.

ATT STANDARDS - ATT-TP 76300, ATT -+P 76416 & ATT UPDATES AS REQUIRED

BUILDING CODE: VIRGINIA UNIFORM STATEWIDE BUILDING CODE 2015 (VUSBC 2015)

ELECTRICAL CODE: NATIONAL ELECTRIC CODE 2014 (NEC 2014)

SUBCONTRACTOR'S WORK SHALL COMPLY WITH THE LATEST EDITION OF THE FOLLOWING STANDARDS:

AMERICAN CONCRETE INSTITUTE (ACI) 318—11, BUILDING CODE REQUIREMENTS FOR STRUCTURAL CONCRETE

AMERICAN INSTITUTE OF STEEL CONSTRUCTION (AISC), MANUAL OF STEEL CONSTRUCTION, ASD, NINTH EDITION.

TELECOMMUNICATIONS INDUSTRY ASSOCIATION (TIA)
TIA 222-G, STRUCTURAL STANDARDS FOR STEEL ANTENNA TOWER AND ANTENNA SUPPORTING STRUCTURES.
TIA 607, COMMERCIAL BUILDING GROUNDING AND BONDING REQUIREMENTS FOR TELECOMMUNICATIONS.

INSTITUTE FOR ELECTRICAL AND ELECTRONICS ENGINEERS (IEEE)
IEEE 81-2012, GUIDE FOR MEASURING EARTH RESISTIVITY, GROUND IMPEDANCE, AND EARTH SURFACE POTENTIALS OF A GROUND SYSTEM.
RECOMMENDED PRACTICE FOR POWERING AND GROUNDING OF ELECTRONIC EQUIPMENT.

IEEE C62.41.2, RECOMMENDED PRACTICES ON SURGE VOLTAGES IN LOW VOLTAGE AC POWER CIRCUITS (FOR LOCATION CATEGORY "C3"

TELCORDIA, GR-1275, GENERAL INSTALLATION REQUIREMENTS.

ANSI T1.311, FOR TELECOM - DC POWER SYSTEMS - TELECOM, ENVIRONMENTAL PROTECTION.

FOR ANY CONFLICTS BETWEEN SECTIONS OF LISTED CODES AND STANDARDS REGARDING MATERIAL, METHODS OF CONSTRUCTION, OR OTHER REQUIREMENTS, THE MOST RESTRICTIVE REQUIREMENT SHALL GOVERN. WHERE THERE IS CONFLICT BETWEEN A GENERAL REQUIREMENT AND A SPECIFIC REQUIREMENT, THE SPECIFIC REQUIREMENT SHALL GOVERN.

NOTES

NOTE: MAGNETIC DECLINATION - 9.71° W ± 0.35° CHANGING BY 0.00° E PER YEAR AS OF 02/18/2020

NO WORK IS TO BE PERFORMED ON THIS SITE WITHOUT REVIEW OF THE APPROVED STRUCTURAL ANALYSIS, IF



SCALE: 1"=2000'(11X17)

Commonwealth

Barracks

	DRAWING APPROVAL SIGN	ATURES
JACOBS SA:		DATE:
JACOBS A&E:		DATE:
JACOBS CM:		DATE:
AT&T CM:		DATE:
AT&T RF:		DATE:
AT&T PM:		DATE:

1"=1000'(24X36)

CHRISTOPHER D. MORIN

ONAL

661 COLUMBIA PIKE SUITE 200 FALLS CHURCH, VA 22041-2 TEL: (703) 671-6000

CV369 CAMP HOLIDAY 10068640 SITE ADDRESS:

700 HOLIDAY TRAILS LANE

CHARLOTTESVILLE, VA 22903




AT&T PROJECTS 2 02-18-20 FINAL CONSTRUCTION DRAWINGS MP NP CDM 11-08-19 FINAL CONSTRUCTION DRAWINGS ME NP CDM 0 11-05-19 FINAL CONSTRUCTION DRAWINGS BPC NP CDM TITLE SHEET A 06-25-19 PRELIMINARY CONSTRUCTION DRAWINGS YT ZS CDM DRAWING NUMBER REV BY CHK APP'D BCREVISIONS 2 SCALE: AS SHOWN DESIGNED YEMESERACH TADDELE

architects

engineers

4801 COX RD SUITE 302 GLEN ALLEN, VA 23060

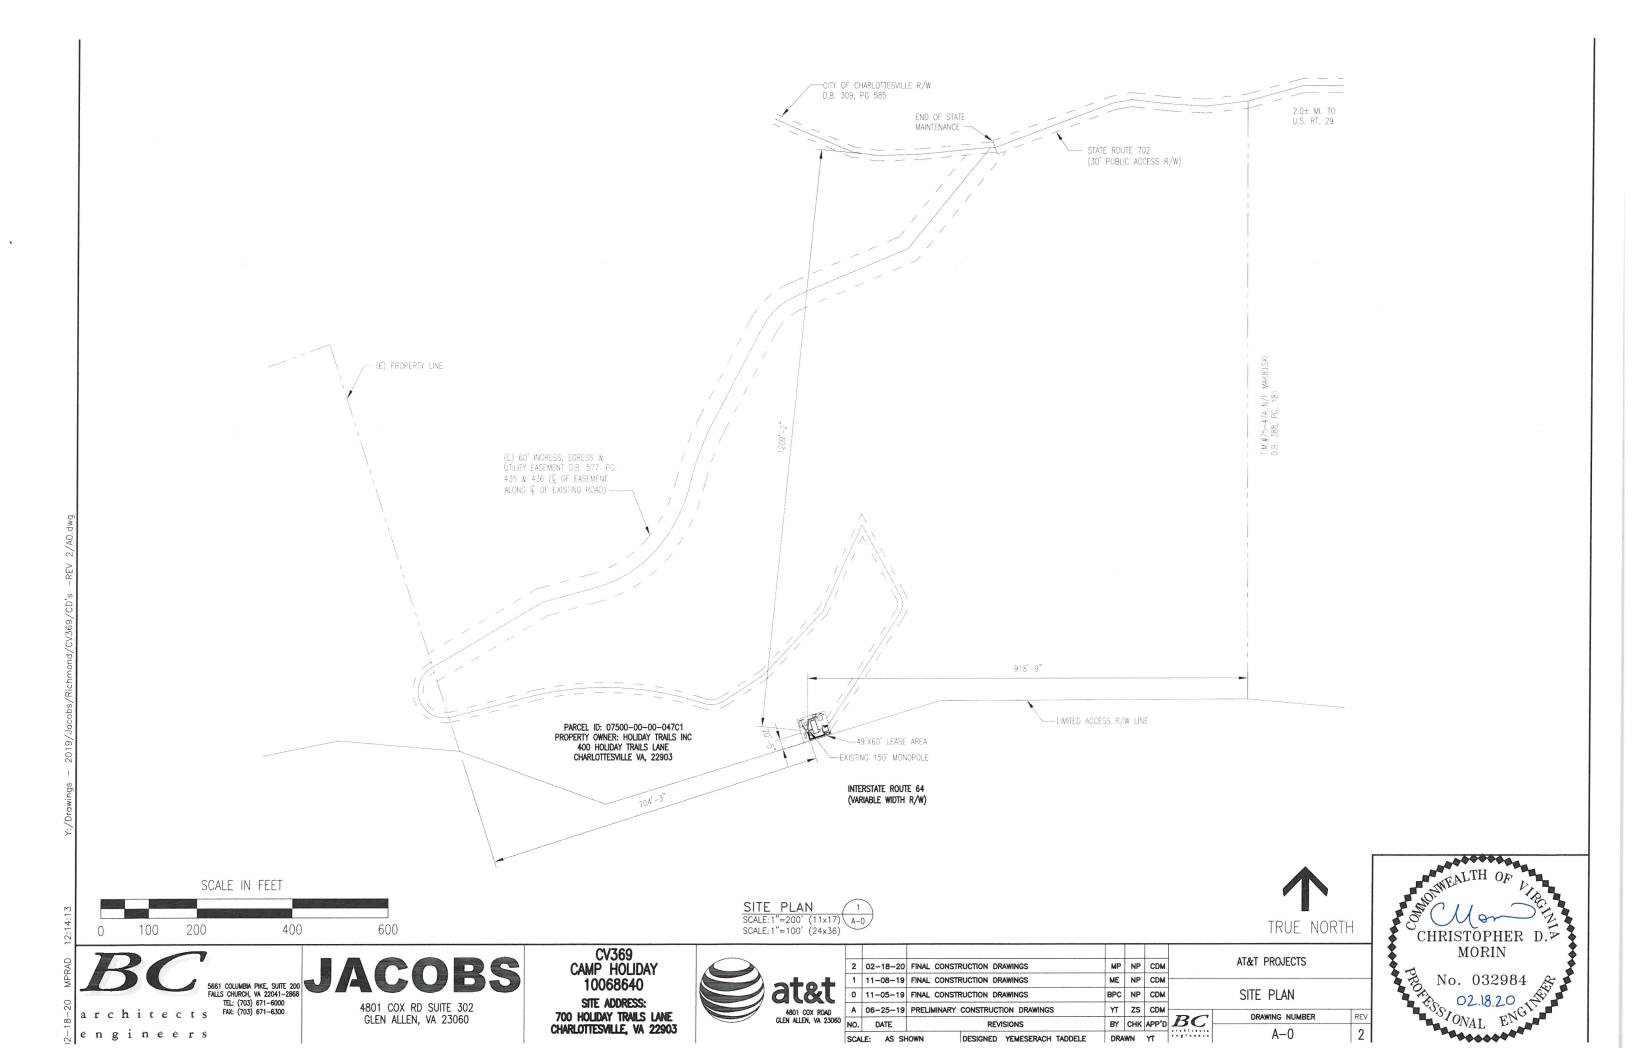



COMPOUND PLAN 1 SCALE: 1"=10" (11×17) SCALE: 1"=5" (24×36)

TRUE NORTH

2

CHRISTOPHER D. MORIN


CV369 CAMP HOLIDAY 10068640 SITE ADDRESS: 700 HOLIDAY TRAILS LANE CHARLOTTESVILLE, VA 22903



	SCALE. AS SHOWN		DESIGNED VENESEDACH TARRELE	DDA	MM	VT	engineers	A-1
60 N	NO.	DATE	REVISIONS	BY	CHK	APP U	1100111011	
		DATE	DO 4010410	D1/	01114	APP'D	RC	DRAWING NUMBER
	Α	06-25-19	PRELIMINARY CONSTRUCTION DRAWINGS	YT	ZS	CDM		DOMENIA MINIDER
				1				
	0	11-05-19	FINAL CONSTRUCTION DRAWINGS	BPC	NP	CDM		COMPOUND PLAN
	1	11-08-19	FINAL CONSTRUCTION DRAWINGS	ME	NP	CDM		
	-							
	2	02-18-20	FINAL CONSTRUCTION DRAWINGS	MP	NP	CDM		AT&T PROJECTS

T engineers

RAWING NUMBER A-1

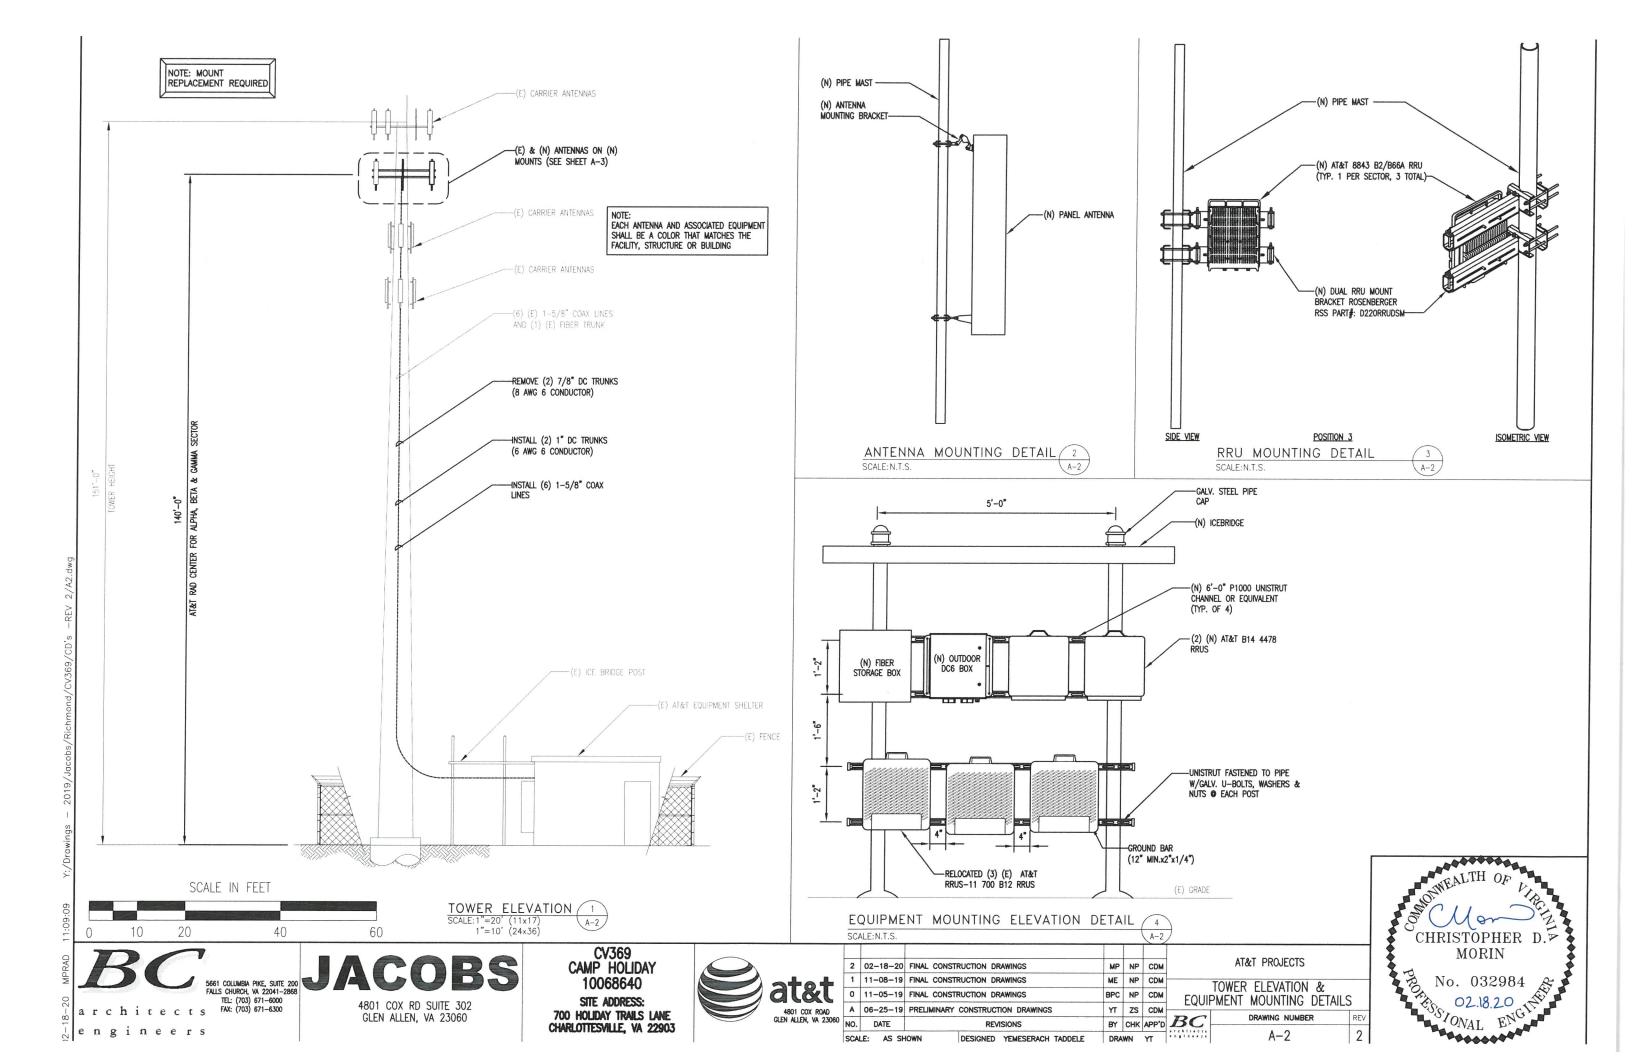


NOTES:

- GENERAL CONTRACTOR IS TO FIELD VERIFY ALL EXISTING ANTENNA RAD CENTERS, ANTENNA TIP HEIGHTS WITH A PRE-TAPE DROP, AND AZIMUTHS PRIOR TO CONSTRUCTION. ALL CHANGES TO THE ANTENNA POSITIONS, AZIMUTHS, AND RAD CENTERS NEED TO BE DISCUSSED WITH RF AND AT&T FIELD CONSTRUCTION MANAGER. ALL CHANGES SHALL BE NOTED ON CONSTRUCTION AS
- TOWER AND TOWER FOUNDATION DESIGN HAS BEEN PREPARED AND PROVIDED BY OTHERS. REFER TO MANUFACTURER'S APPROVED TOWER DRAWINGS OR CURRENT STRUCTURAL ANALYSIS. THE RF RAD CENTER OF THE PROPOSED ANTENNAS AND MOUNTING PLATFORM ARE BASED ON INFORMATION PROVIDED THROUGH AT&T.
- THIS DRAWING IS A GRAPHICAL REPRESENTATION OF THE TOWER, THE RF RAD CENTER OF THE PROPOSED ANTENNAS AND PROPOSED MOUNTING PLATFORM/SECTOR FRAME BASED ON INFORMATION PROVIDED THROUGH AT&T, AND /OR ANALYZED BY OTHERS. BC ARCHITECTS ENGINEERS CERTIFIES ONLY THAT INFORMATION PROVIDED TO BC ARCHITECTS ENGINEERS FOR THE PREPARATION OF THESE PLANS AND IS NOT CERTIFYING NOR WARRANTING THE DESIGN NOR VERIFYING THE ANALYTICAL RESULTS OF THE STRUCTURAL ANALYSIS PERFORMED BY OTHERS
- THE CONTRACTOR SHALL VERIFY THE LOCATION OF THE PROPOSED CABLES, CABLE LADDER, AND/OR OTHER CABLE SUPPORTING SYSTEM PER CURRENT STRUCTURAL ANALYSIS.
- ALL COAX CABLES SHALL BE STACKED IN ACCORDANCE WITH THE CURRENT STRUCTURAL ANALYSIS. THE CONTRACTOR OR SUBCONTRACTOR SHALL FURNISH AND INSTALL CABLE LADDER RACK, CABLE TRAYS, ETC., AND/OR CONDUIT AS REQUIRED TO SUPPORT CABLES
- THE CONTRACTOR SHALL VERIFY WITH CONSTRUCTION TURF VENDORS 48 HOURS PRIOR TO INSTALLATION OF ALL EQUIPMENT/RF CONFIGURATION AND ANY RELATED WORK RELATED TO THE COMPLETION OF THIS PROJECT.
- 7. THIS DRAWING IS FOR GENERAL INFORMATION ONLY


TOWER SCOPE OF WORK:

- REMOVE (3) RRUS-11 (700) RRUS (TO BE USED BOTTOMSIDE) (1 PER SECTOR)
- REMOVE (2) 7/8" DC TRUNKS (8 AWG 6 CONDUCTOR)
- REMOVE (6) TMAS (2 PER SECTOR)
- REMOVE (1) FLUSH MOUNT
- INSTALL (1) COMMSCOPE MTC4047M6996 MOUNT
- INSTALL (3) HPA-45R-BUU-H4-K ANTENNAS ON (N) MOUNTS (1 PER SECTOR)
- RE-INSTALL (3) 80010891 ON (N) MOUNTS (1 PER SECTOR)
- INSTALL (6) 1-5/8" COAX LINES
- INSTALL (3) TMAT192123B68-21 TMA'S (1 PER SECTOR)
- INSTALL (3) DUAL RRH MOUNTS BEHIND (E) ANTENNAS (1 PER SECTOR)
- INSTALL (3) 8843 B2/B66A (1900/2100) RRU'S ON (N) DUAL RRU MOUNT (1 PER SECTOR)
- 12. INSTALL (6) SFP7 CARDS IN (N) 8843 B2/B66A RRU'S (2 PER RRU)
- 13. RE-INSTALL (1) DC6/DOME
- 14. INSTALL (24) 1/2" JUMPERS FROM (N) RRU'S TO (E) ANTENNAS (8 PER SECTOR)
- 15. INSTALL (12) 1/2" JUMPERS FROM (N) TMAS TO (E) AND (N) ANTENNAS (4 PER SECTOR)

- 16. INSTALL (6) 1/2" JUMPERS FROM (N) 1-5/8" COAX LINES TO (N) ANTENNAS (2 PER SECTOR)
- 17. INSTALL (6) 1/2" JUMPERS FROM (E) 1-5/8" COAX LINES TO (N) TMAS (2 PER SECTOR)
- 18. INSTALL (3) RET CABLES FROM (N) 8843 B2/B66A RRUS TO (E) ANTENNAS (1 PER SECTOR)
- 19. INSTALL (3) RET CABLES FROM (N) ANTENNA TO (E) ANTENNAS (1 PER SECTOR)
- 20. INSTALL (2) 1" DC TRUNKS (6 AWG 6 CONDUCTOR) FROM (E) DC12 TO (E) DC6/DOME
- 21. RE-INSTALL (1) FIBER TRUNK TO (E) DC6/DOME
- 22. INSTALL (3) DUAL PAIR FIBER JUMPERS FROM (E) DC6/DOME TO (N) 8843 B2/B66A RRUS (1
- 23. INSTALL (6) 2/C #10 DC POWER CABLES FROM (E) DC6/DOME TO (N) 8843 B2/B66A RRUS (2 PER RRU)
- 24. LABEL ALL ANTENNAS/RRUS WITH P-TOUCH LABELS
- INSTALL RF LOADS ON ALL UNUSED RRU PORTS. (6 TOTAL)
- 26. SECURE RET CABLES AND FIBERS WITH SNAPS INS AND GROMMETS.
- 27. COLOR CODE JUMPERS PER DETAILS.N (E) LTE RACK
- 28. LABEL ALL POWER/FIBER

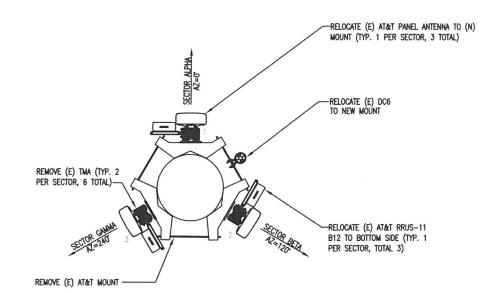

NOTE: MOUNT REPLACEMENT REQUIRED 1. HPA-45R-BUU-H4 ANTENNA AREA= 943.11 SQ. INCHES EACH ANTENNA AND ASSOCIATED EQUIPMENT SHALL BE A COLOR THAT MATCHES THE FACILITY, STRUCTURE OR BUILDING

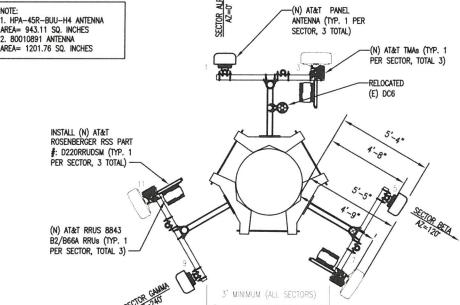

TRUE NORTH



EXISTING ANTENNA PLAN 1 SCALE:3/16"=1' (11x17 SCALE:3/8"=1' (24x36)

TRUE NORTH



PROPOSED ANTENNA PLAN SCALE:3/16"=1' (11x17 SCALE:3/8"=1' (24x36)

WEALTH OF CHRISTOPHER D. MORIN

ONAL

5661 COLUMBIA PIKE, SUITE 200 FALLS CHURCH, VA 22041-2868

4801 COX RD SUITE 302

GLEN ALLEN, VA 23060

CAMP HOLIDAY 10068640 SITE ADDRESS: 700 HOLIDAY TRAILS LANE CHARLOTTESVILLE, VA 22903

CV369



MP NP CDM 2 02-18-20 FINAL CONSTRUCTION DRAWINGS ME NP CDM 1 11-08-19 FINAL CONSTRUCTION DRAWINGS BPC NP CDM 0 11-05-19 FINAL CONSTRUCTION DRAWINGS A 06-25-19 PRELIMINARY CONSTRUCTION DRAWINGS YT ZS CDM DATE REVISIONS

AT&T PROJECTS EXISTING & PROPOSED ANTENNA PLANS DRAWING NUMBER BY CHK APP'D BC2 A-3DRAWN YT SCALE: AS SHOWN DESIGNED YEMESERACH TADDELE

engineers

FAX: (703) 671-6300