Verizon

DIRECTIONS FROM GOODES BRIDGE SWITCH (2501 GOODES BRIDGE RD., RICHMOND, VA 23224):

HEAD NORTH ON GOODES BRIDGE RD. 0.4 MI, TURN RIGHT ONTO US-360E. 0.2 MI, MERGE ONTO VA-150N/CHIPPENHAM PKWY VIA THE RAMP TO 195N/POWHITE PKWY. 0.1 MI, MERGE ONTO VA-150N/CHIPPENHAM VA-15UN/CHIPPENHAM PRWY VIA THE KAMP TO 195N/POWHITE PKWY. 0.1 MI, MERGE ONTO VA-15UN/CHIPPENHAM PKWY. 2.2 MI, USE THE RIGHT 2 LANES TO MERGE ONTO VA-6N/POWHITE PKWY. 0.8 MI, KEEP LEFT TO CONTINUE ON VA-76N. 1.8 MI, KEEP LEFT TO CONTINUE ON VA-76N. 0.9 MI, CONTINUE ONTO I-195N. 2.2 MI, USE THE LEFT 2 LANE TO TAKE THE I-64W EXIT TOWARD CHARLOTTESVILLE. 0.6 MI, MERGE ONTO I-64. 64.2 MI, TAKE EXIT 121 TOWARD VA-2OS. 0.2 MI, TURN LEFT ONTO VA-2OS. 1.5 MI, TURN IGHT ONTO MILL CREEK DR. 0.8 MI, TURN LEFT ONTO AVON STREET EXT. 0.2 MI, TURN LEFT. 499 FT, ARRIVE AT DESTINATION.

DIRECTIONS





AVON

1739 AVON STREET EXT CHARLOTTESVILLE, VA 22902

E911 ADDRESS YES⊠ NO□

PROJECT DESCRIPTION

UPGRADE OF ANTENNAS AND ASSOCIATED EQUIPMENT IN AN EXISTING WIRELESS COMPOUND



WORKING DAYS BEFORE YOU DIG 811 TOLL FREE

EMERGENCY INFO: JURISDICTION: ALBEMARLE COUNTY LOCAL FIRE AND RESCUE: 434.296.5833

LOCAL POLICE: 434.296.5807

PROJECT TEAM REAL ESTATE: EMILY DA SILVA PHONE NUMBER: 804.852.8089 CONSTRUCTION: JON KIRBY PHONE NUMBER: 540,280,9630

REV. NO.	DESCRIPTION	BY	DATE	REV.	NO.	DESCRIPTION	BY	DATE
0	FOR CONSTRUCTION	LMW	04/05/23					
1	ZONING COMMENTS	LMW	04/13/23	,- ,-	_			
								 8

A & E CONSULTING TEAM

ARCHITECTURE AND ENGINEERING: DEWBERRY ENGINEERS INC. 4805 LAKE BROOK DRIVE, SUITE 200 GLEN ALLEN, VA 23060

PHONE # 804.205.3348 CONTACT: HILLARY SIEGALL, P.E.: VA

PHONE # 540.926.3857 CONTACT: JUSTIN YOON, P.E.: MD, DC, VA, WV, NC, FL, LEED AP

ALL WORK SHALL BE PERFORMED IN ACCORDANCE WITH THE CURRENT EDITIONS OF THE FOLLOWING CODES AS ADOPTED BY THE GOVERNING AUTHORITIES.

- 2018 INTERNATIONAL BUILDING CODE (IBC)

AMSI/TIA-222-H
ANTENNA SUPPORTING STRUCTURES AND ANTENNAS HAVE
BEEN DESIGNED IN ACCORDANCE WITH THE IBC 2018
SECTION 1609 WIND LOADS, EXCEPTION #5 REFERENCING

2017 NATIONAL ELECTRIC CODE (NEC)
 2018 NFPA 101, LIFE SAFETY CODE
 MANUAL OF STEEL CONSTRUCTION, 14th EDITION

AMERICAN CONCRETE INSTITUTE

- LOCAL BUILDING CODE - CITY/COUNTY ORDINANCES

PHONE # 804.205.3353
CONTACT: BRAD ROSE, SENIOR PROJECT MANAGER

PROPERTY OWNER: ALBEMARLE COUNTY SERVICE AUTHORITY 168 SPOTNAP ROAD CHARLOTTESVILLE, VA 22911

PROJECT INFO:
CANDIDATE NAME: AVON
PROJECT TYPE: 5G L-SUB6 — CARRIER ADD
FUZE PROJECT ID#: 16824886

APPLICANT INFO: VERIZON WIRELESS 1831 RADY COURT RICHMOND, VA 23222 PHONE: 804.306.0275 CONTACT: BROCK SMITH

PROJECT DATA:
ZONING: R1
PARCEL ID: 09100-00-00-00100 TAX MAP: 1089/670 ACREAGE: 10.53 AC JURISDICTION: ALBEMARLE COUNTY SITE TYPE: EMBEDDED BASE UPGRADE TOWER TYPE: MONOPOLE OVERALL/STRUCTURE HEIGHT: 89'

<u>CENTER OF EXISTING TOWER*:</u>
LATITUDE: 37° 59' 52.30" N / 37.997861
LONGITUDE: 78° 29' 52.90" W / -78.498028 *PER RFDS BY VERIZON WIRELESS DATED FEBRUARY 02, 2023 AND GOOGLE EARTH

THIS DOCUMENT WAS DEVELOPED TO REFLECT A SPECIFIC SITE AND ITS SITE CONDITIONS AND IS NOT TO BE USED FOR ANOTHER SITE OR WHEN OTHER CONDITIONS PERTAIN. REUSE OF THIS DOCUMENT IS AT THE SOLE

A.D.A. COMPLIANCE:

FACILITY IS UNMANNED AND NOT FOR HUMAN HABITATION.

PROJECT SUMMARY

TOWER OWNER:

AMERICAN TOWER CORPORATION
116 HUNTINGTON AVE. 11TH FLOOR
BOSTON, MA 02116

G-1 GENERAL NOTES Z-1 SITE PLAN & ELEVATION

T-1 TITLE SHEET

DESCRIPTION

Z-2 EXISTING & PROPOSED ANTENNA CONFIGURATION Z-3 EQUIPMENT DETAILS Z-4 EQUIPMENT DETAILS

INDEX OF DRAWINGS

1737 AVON STREET EXT CHARLOTTESVILLE, VA 22902

SHEET TITLE

TITLE SHEET

SHEET NUMBER

— 1



1831 RADY COURT RICHMOND, VA 23222

AVON

	ZONING	DRAWINGS
1	04/13/23	ZONING COMMENTS
0	04/13/23	FOR ZONING



Dewberry Engineers Inc. 4805 Lake Brook Drive, Suite 200 Glen Allen, VA 23060 Phone: 804.290.7957 Fax: 804.290.7928 www.dewberry.com



DRAWN BY:	LMW
REVIEWED BY:	JYY
CHECKED BY:	JYY
PROJECT NUMBER:	50160159

GENERAL CONSTRUCTION NOTES:

- ALL WORK SHALL CONFORM TO ALL CURRENT APPLICABLE FEDERAL, STATE, AND LOCAL CODES, INCLUDING ANSI/EIA/TIA-222, AND COMPLY WITH VERIZON WIRELESS SPECIFICATIONS.
- 2. CONTRACTOR SHALL CONTACT "MISS UTILITY" (1-800-552-7001) FOR IDENTIFICATION OF UNDERGROUND UTILITIES PRIOR TO START OF CONSTRUCTION
- 3. CONTRACTOR IS RESPONSIBLE FOR COORDINATING ALL REQUIRED INSPECTIONS.
- ALL DIMENSIONS TO, OF, AND ON EXISTING BUILDINGS, DRAINAGE STRUCTURES, AND SITE IMPROVEMENTS SHALL BE VERIFIED IN FIELD BY CONTRACTOR WITH ALL DISCREPANCIES REPORTED TO THE ENGINEER.
- 5. DO NOT CHANGE SIZE OR SPACING OF STRUCTURAL ELEMENTS.
- 6. DETAILS SHOWN ARE TYPICAL; SIMILAR DETAILS APPLY TO SIMILAR CONDITIONS UNLESS OTHERWISE NOTED.
- THESE DRAWINGS DO NOT INCLUDE NECESSARY COMPONENTS FOR CONSTRUCTION SAFETY WHICH IS THE SOLE
- CONTRACTOR SHALL BRACE STRUCTURES UNTIL ALL STRUCTURAL ELEMENTS NEEDED FOR STABILITY ARE INSTALLED. THESE ELEMENTS ARE AS FOLLOWS: LATERAL BRACING, ANCHOR BOLTS, ETC.
- 9. CONTRACTOR SHALL DETERMINE EXACT LOCATION OF EXISTING UTILITIES, DRAIN PIPES, VENTS, ETC. BEFORE COMMENCING
- 10. INCORRECTLY FABRICATED, DAMAGED, OR OTHERWISE MISFITTING OR NONCONFORMING MATERIALS OR CONDITIONS SHALL BE REPORTED TO THE OWNER PRIOR TO REMEDIAL OR CORRECTIVE ACTION. ANY SUCH REMEDIAL ACTION SHALL REQUIRE WRITTEN APPROVAL BY THE OWNER'S REPRESENTATIVE PRIOR TO PROCEEDING
- 11. EACH CONTRACTOR SHALL COOPERATE WITH THE OWNER'S REPRESENTATIVE, AND COORDINATE HIS WORK WITH THE WORK
- CONTRACTOR SHALL REPAIR ANY DAMAGE CAUSED BY CONSTRUCTION OF THIS PROJECT TO MATCH EXISTING PRE-CONSTRUCTION CONDITIONS TO THE SATISFACTION OF THE VERIZON WIRELESS CONSTRUCTION MANAGER.
- 13. ALL CABLE/CONDUIT ENTRY/EXIT PORTS SHALL BE WEATHERPROOFED DURING INSTALLATION USING A SILICONE SEALANT.
- 14. WHERE EXISTING CONDITIONS DO NOT MATCH THOSE SHOWN IN THIS PLAN SET, CONTRACTOR WILL NOTIFY ENGINEER, VERIZON WIRELESS PROJECT CONSTRUCTION MANAGER, AND LANDLORD IMMEDIATELY
- CONTRACTOR SHALL ENSURE ALL SUBCONTRACTORS ARE PROVIDED WITH A CURRENT SET OF DRAWINGS AND SPECIFICATIONS FOR THIS PROJECT.
- ALL ROOF WORK SHALL BE DONE BY A QUALIFIED AND EXPERIENCED ROOFING CONTRACTOR IN COORDINATION WITH ANY
 CONTRACTOR WARRANTING THE ROOF TO ENSURE THAT THE WARRANTY IS MAINTAINED.
- 17. CONTRACTOR SHALL REMOVE ALL RUBBISH AND DEBRIS FROM THE SITE AT THE END OF EACH DAY.
- 18. CONTRACTOR SHALL COORDINATE WORK SCHEDULE WITH LANDLORD AND TAKE PRECAUTIONS TO MINIMIZE IMPACT AND DISRUPTION OF OTHER OCCUPANTS OF THE FACILITY
- 19. CONTRACTOR SHALL FURNISH VERIZON WIRELESS WITH THREE AS-BUILT SETS OF DRAWINGS UPON COMPLETION OF WORK.
- 20. ANTENNAS AND CABLES ARE TYPICALLY PROVIDED BY VERIZON WIRELESS. PRIOR TO SUBMISSION OF BID, CONTRACTOR SHALL COORDINATE WITH VERIZON WIRELESS PROJECT MANAGER TO DETERMINE WHAT, IF ANY, ITEMS WILL BE PROVIDED BY VERIZON WIRELESS. ALL ITEMS NOT PROVIDED BY VERIZON WIRELESS SHALL BE PROVIDED AND INSTALLED BY THE CONTRACTOR. CONTRACTOR WILL INSTALL ALL ITEMS PROVIDED BY VERIZON WIRELESS.
- 21. PRIOR TO SUBMISSION OF BID, CONTRACTOR WILL COORDINATE WITH VERIZON WIRELESS PROJECT MANAGER TO DETERMINE IF ANY PERMITS WILL BE OBTAINED BY VERIZON WIRELESS. ALL REQUIRED PERMITS NOT OBTAINED BY VERIZON WIRELESS MUST BE OBTAINED, AND PAID FOR, BY THE CONTRACTOR.
- 22. GENERAL CONTRACTOR SHALL HAVE A LICENSED HVAC CONTRACTOR START THE HVAC UNITS, SYNCHRONIZE THE THERMOSTATS, ADJUST ALL SETTINGS ON EACH UNIT ACCORDING TO VERIZON WIRELESS CONSTRUCTION MANAGER'S SPECIFICATIONS, AND THOROUGHLY TEST AND BALANCE EACH UNIT TO ENSURE PROPER OPERATION PRIOR TO TURNING THE SITE OVER TO OWNER.
- 23. CONTRACTOR SHALL INSTALL ALL SITE SIGNAGE IN ACCORDANCE WITH VERIZON WIRELESS SPECIFICATIONS AND REQUIREMENTS.
- 24. CONTRACTOR SHALL SUBMIT ALL SHOP DRAWINGS TO ENGINEER FOR REVIEW AND APPROVAL PRIOR TO FABRICATION.
- 25. UNLESS OTHERWISE NOTED VERIZON WIRELESS SHALL PROVIDE ALL REQUIRED RF MATERIAL FOR CONTRACTOR TO INSTALL, INCLUDING ANTENNAS, TMA'S, BIAS-T'S, COMBINERS, PDU, DC BLOCKS, SURGE ARRESTORS, GPS ANTENNA, GPS SURGE ARRESTOR, COAXIAL CABLE.
- 26. PRIOR TO SUBMISSION OF BID, CONTRACTOR SHALL VERIFY ALL EQUIPMENT TO BE PROVIDED BY VERIZON WIRELESS FOR INSTALLATION BY CONTRACTOR.
- 27. CONTRACTOR SHALL FURNISH AND INSTALL ANTENNA PLATFORM.
- 28. ALL EQUIPMENT SHALL BE INSTALLED ACCORDING TO MANUFACTURER'S SPECIFICATIONS AND LOCATED ACCORDING TO VERIZON WIRELESS SPECIFICATIONS, AND AS SHOWN IN THESE PLANS.
- 29. FOUIPMENT CABINET FRAME/SHELTER SHALL BE ANCHORED TO FOUNDATION PER MANUFACTURER'S SPECIFICATIONS AND IN ACCORDANCE WITH STATE BUILDING CODE.
- THE CONTRACTOR SHALL SUPERVISE AND DIRECT THE PROJECT DESCRIBED HEREIN. THE CONTRACTOR SHALL BE SOLELY RESPONSIBLE FOR ALL CONSTRUCTION MEANS, METHODS, TECHNIQUES, SEQUENCES AND PROCEDURES AND FOR COORDINATING ALL PORTIONS OF THE WORK UNDER CONTRACT.
- 31. CONTRACTOR SHALL NOTIFY THE ENGINEER A MINIMUM OF 48 HOURS IN ADVANCE PRIOR TO CONSTRUCTION START, MORE SPECIFICALLY BEFORE; SEALING ANY FLOOR, WALL OR ROOF PENETRATION, FINAL UTILITY CONNECTIONS, POURING CONCRETE, BACKFILLING UTILITY TRENCHES AND STRUCTURAL POST OR MOUNTING CONNECTIONS, FOR ENGINEERING REVIEW
- 32. CONTRACTOR SHALL BE RESPONSIBLE FOR SITE SAFETY INCLUDING COMPLIANCE WITH ALL APPLICABLE OSHA STANDARDS AND RECOMMENDATIONS AND SHALL PROVIDE ALL NECESSARY SAFETY DEVICES INCLUDING PPE AND PPM AND CONSTRUCTION DEVICES SUCH AS WELDING AND FIRE PREVENTION, TEMPORARY SHORING, SCAFFOLDING, TRENCH
- 33. DETECTION WIRE SHALL BE BURIED DIRECTLY ABOVE NON-METALLIC PIPING AT A DISTANCE NOT TO EXCEED TWELVE (12) INCHES ABOVE THE TOP OF PIPE. THE WIRE SHALL EXTEND CONTINUOUSLY AND UNBROKEN FROM POINT OF ACCESS TO POINT OF ACCESS. THE ENDS OF THE WIRE SHALL EXEMINATE WITH A MINIMUM OF THREE (3) FEET OF WIRE, COILED, REMAINING ACCESSIBLE AT TERMINATION POINTS. DETECTION WIRE SHALL BE 12 GAUGE FOR A BURIED DEPTH OF LESS THAN 4 FEET AND 4 GAUGE FOR A BURIED DEPTH GREATER THAN OR EQUAL TO 4 FEET.

DESIGN CRITERIA:

SEE MOUNT ANALYSIS, MOUNT MODIFICATION DESIGN (IF APPLICABLE), AND STRUCTURAL ANALYSIS.

EXISTING CONDITIONS

- THE EXISTING CONSTRUCTION SHOWN ON THESE DRAWINGS IS PROVIDED FOR REFERENCE ONLY. EXISTING CONSTRUCTION, DIMENSIONS, LOCATIONS, ELEVATIONS, ETC. SHALL BE VERIFIED IN THE FIELD PRIOR TO REMOVAL OR MODIFICATION OF ANY EXISTING STRUCTURAL MEMBER AND/OR SHOP DRAWING PREPARATION, FABRICATION, AND ADMINISTRATION OF ANY EXISTING STRUCTURAL MEMBER AND/OR SHOP DRAWING PREPARATION, FABRICATION, AND ADMINISTRATION OF ANY EXISTING STRUCTURAL MEMBER AND/OR SHOP DRAWING PREPARATION, FABRICATION, AND ADMINISTRATION OF ANY EXISTING STRUCTURAL MEMBER AND/OR SHOP DRAWING PREPARATION, FABRICATION, AND ADMINISTRATION OF ANY EXISTING STRUCTURAL MEMBER AND/OR SHOP DRAWING PREPARATION, FABRICATION, AND ADMINISTRATION OF ANY EXISTING STRUCTURAL MEMBER AND/OR SHOP DRAWING PREPARATION, FABRICATION, AND ADMINISTRATION OF ANY EXISTING STRUCTURAL MEMBER AND/OR SHOP DRAWING PREPARATION, FABRICATION, AND ADMINISTRATION OF ANY EXISTING STRUCTURAL MEMBER AND/OR SHOP DRAWING PREPARATION, FABRICATION, AND ADMINISTRATION OF ANY EXISTING STRUCTURAL MEMBER AND/OR SHOP DRAWING PREPARATION, FABRICATION, AND ADMINISTRATION OF ANY EXISTING STRUCTURAL MEMBER AND/OR SHOP DRAWING PREPARATION, FABRICATION, AND ADMINISTRATION OF ANY EXISTING STRUCTURAL MEMBER AND/OR SHOP DRAWING PREPARATION, FABRICATION, AND ADMINISTRATION OF ANY EXISTING STRUCTURAL MEMBER AND/OR SHOP DRAWING PREPARATION, FABRICATION, AND ADMINISTRATION OF ANY EXISTING STRUCTURAL MEMBER AND/OR SHOP DRAWING PREPARATION, FABRICATION, AND ADMINISTRATION OF ANY EXISTING STRUCTURAL MEMBER AND/OR SHOP DRAWING PREPARATION, FABRICATION, AND ADMINISTRATION OF ANY EXISTENCE PROPERTY OF A SHOP DRAWING PROPERTY OF A SHOP DRAWI
- 2. SHOULD EXISTING CONDITIONS DIFFER FROM THAT SHOWN ON THE CONTRACT DOCUMENTS, NOTIFY THE DESIGN PROFESSIONAL PRIOR TO CONTINUATION OF WORK
- 3. EXISTING STRUCTURAL MEMBERS SHALL NOT BE CUT OR MODIFIED UNLESS SPECIFICALLY SHOWN HEREIN OR UNLESS APPROVED IN WRITING BY THE DESIGN PROFESSIONAL.
- 4. THE CONTRACTOR SHALL TAKE NECESSARY PRECAUTIONS TO PROTECT THE EXISTING STRUCTURE AND ADJACENT STRUCTURES FROM DAMAGE DURING EXCAVATION, DEMOLITION, AND CONSTRUCTION OF NEW WORK.
- IF EXISTING STRUCTURAL DOCUMENTS ARE NOT AVAILABLE FROM THE OWNER, VERIFY IN FIELD EXISTING CONDITIONS, STRUCTURAL MEMBER SIZES, AND LOCATIONS.

MEANS AND METHODS

- 1. THE CONTRACTOR IS RESPONSIBLE FOR PROVIDING MEANS AND METHODS FOR THE CONSTRUCTION OF THE
- THE CONTRACTOR SHALL ENGAGE A PROFESSIONAL ENGINEER FOR MEANS AND METHODS OF CONSTRUCTION, INCLUDING BUT NOT LIMITED TO SCAFFOLDING, SHORING, UNDERPINNING, TEMPORARY BRACING, HOISTING, AND STORING OF MATERIALS OR EQUIPMENT ON THE EXISTING STRUCTURE, ETC.
- 3. THE CONTRACTORS ENGINEER SHALL REFER TO SITE STANDARDS AND GUIDELINES FOR ADDITIONAL REQUIREMENTS.
- THE CONTRACTOR SHALL INSPECT, ASSESS, AND VERIFY THE EXISTING CONDITIONS AND EXTENT OF WORK PRIOR TO COMMENCING DEMOLITION OR CONSTRUCTION OF NEW WORK.
- THE CONTRACTOR SHALL PROVIDE NECESSARY EQUIPMENT AND OTHER PERTINENT MATERIAL, INCLUDING BUT NOT LIMITED TO LADDERS, LIFTS AND OTHER CONSTRUCTION EQUIPMENT FOR THE COMPLETION OF THE WORK INDICATED ON THE CONTRACT DOCUMENTS.
- THE CONTRACTOR SHALL PROVIDE SAFETY AND FALL PROTECTION IN ACCORDANCE WITH OSHA REGULATIONS AND SITE SAFETY GUIDELINES.

STRUCTURAL STEEL FRAMING

- 1. THE STRUCTURE HAS BEEN DESIGNED IN CONFORMANCE WITH THE "ALLOWABLE STRENGTH DESIGN SPECIFICATION FOR STRUCTURAL STEEL BUILDINGS" OF THE AMERICAN INSTITUTE OF STEEL CONSTRUCTION (AISC)
- 2. STRUCTURAL STEEL SHALL COMPLY WITH THE FOLLOWING UNLESS OTHERWISE NOTED:

ASTM A992/A992M ASTM A36/A36M WIDE FLANGE CHANNELS

ASTM A36/A36M ANGLES AND PLATES

ASIM ASOO, GRADE B Fy=46 KSI
ASTM ASOO, GRADE B Fy=46 KSI
ASTM ASO1 OR A53, TYPE E OR S
STEEL PIPE

THE STREET AS THE STREET AS

ASTM F1554/F1554, Fy=36 KSI ANCHOR BOLTS

- 3. BOLTS SHALL COMPLY WITH ASTM A325 OR A490. NUTS AND WASHERS SHALL BE COMPATIBLE WITH THE BOLT GRADE, HOLE SIZE, CONNECTION TYPE AND INSTALLATION METHOD AS INDICATED IN "SPECIFICATION FOR STRUCTURAL JOINTS USING ASTM A325 OR A490 BOLTS".
- CONNECTIONS SHALL BE BOLTED WITH 3/4 INCH DIAMETER A325—X HIGH STRENGTH BOLTS OR WELDED, UNLESS OTHERWISE NOTED. MINIMUM CONNECTIONS SHALL BE DESIGNED TO SUPPORT NOT LESS THAN 6 KIPS IN ANY DIRECTION. PROVIDE A MINIMUM OF TWO (2) BOLTS PER CONNECTION SPACED AT 3 INCHES ON CENTER VERTICAL.
- 5. WELDING SHALL CONFORM TO THE AMERICAN WELDING SOCIETY (AWS) "STRUCTURAL WELDING CODE STEEL". WELDING SHALL BE DONE BY QUALIFED WELDERS CERTIFIED IN ACCORDANCE WITH AWS D1.1, "STRUCTURAL WELDING CODE STANDARD QUALIFICATION PROCEDURE" AND AWS D1.3, "STRUCTURAL WELDING CODE STRUCTURAL STEEL". WELDING ELECTRODES SHALL BE E70XX. FILLET WELDS SHALL BE NO LESS THAN 1/4 INCH AND SHALL COMPLY WITH AISC.
- STEEL SHOP DRAWINGS AND FABRICATION SHALL CONFORM TO THE AISC CODE OF STANDARD PRACTICE FOR STEEL BUILDINGS AND BRIDGES.
- 7. STRUCTURAL STEEL SHOP DRAWINGS, INCLUDING CONNECTIONS, SHALL BE PREPARED UNDER THE DIRECTION OF A PROFESSIONAL STRUCTURAL ENGINEER, REGISTERED IN THE STATE WHERE THE CONSTRUCTION IS LOCATED. THE ENGINEER, EMPLOYED BY THE CONTRACTOR, SHALL PREPARE A SIGNED AND SEALED LETTER OF CERTIFICATION STATING THAT THE STRUCTURAL STEEL SHOP DRAWINGS, INCLUDING CONNECTIONS, HAVE BEEN PREPARED UNDER THEIR DIRECTION. THE STROUTONG STEEL SHOP DOWNINGS, INCLUDING CONNECTIONS, PANCED FOR PROPERTY OF THE SUBMITTAL OF THE STRUCTURAL STEEL SHOP DRAWINGS. SHOP DRAWINGS WILL NOT BE REVIEWED BY THE OWNER'S ENGINEER OF RECORD WITHOUT THE RECEIPT AND ACCEPTANCE OF THE CERTIFICATION LETTER.
- 8. STRUCTURAL STEEL FABRICATION SHALL BE PERFORMED BY AN ORGANIZATION EXPERIENCED IN STRUCTURAL FABRICATION OF EQUIVALENT MAGNITUDE TO THIS PROJECT, AND HAS AN AISC CERTIFICATION FOR STRUCTURAL STEELWORK, PROVIDE, WITH THE BID, A COPY OF THE AISC CETTIFICATE INDICATING THAT THE FABRICATOR HAST MADE SAISC CATEGORY STD. CERTIFICATION. IN LIEU OF AN AISC CERTIFICATION, THE FABRICATOR MAY SUBMIT DOCUMENTATION OF EQUIVALENT EXPERIENCE IN THE FABRICATION OF THE ITEM OR ITEMS IN QUESTION, FOR REVIEW AND APPROVAL BY THE OWNER'S
- 9. STRUCTURAL STEEL EXPOSED TO WEATHER SHALL BE PREPPED BY COMMERCIAL BLAST CLEANING THEN HOT-DIPPED
- SPLICING OF STRUCTURAL STEEL SECTIONS, NOT INDICATED ON CONTRACT DOCUMENTS, IS PROHIBITED WITHOUT PRIOR WRITTEN APPROVAL BY THE STRUCTURAL ENGINEER OF RECORD.
- 11. HOLLOW STRUCTURAL SECTIONS SHALL HAVE A 3/8 INCH CAP PLATE, UNLESS OTHERWISE NOTED.
- 12. PROVIDE 3/8 INCH THICK MINIMUM WELDED STIFFENER PLATE ON BOTH SIDES OF THE WEB OF BEAMS AT POINT OF CONCENTRATED LOADS SUCH AS BEAMS SUPPORTING COLUMNS/POSTS OR RUNNING OVER TOPS OF COLUMNS, POSTS, OR OTHER BEAMS.
- 13. STEEL FABRICATOR IS SOLELY RESPONSIBLE FOR SURVEYING AND VERIFICATION OF EXISTING CONDITIONS INCLUDING BUT NOT LIMITED TO THE LOCATIONS, ELEVATIONS, AND DIMENSIONS OF EXISTING WALLS AND FRAMING.



VERIZON WIRELESS 1831 RADY COURT RICHMOND, VA 23222


AVON

	ZONING	DRAWINGS
_		
1	04/13/23	ZONING COMMENTS
0	04/05/23	FOR ZONING



Dewberry Engineers Inc.

4805 Lake Brook Drive, Suite 200 Glen Allen, VA 23060 Phone: 804.290.7957 Fax: 804.290.7928

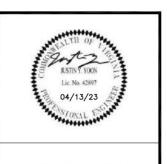


DRAWN BY:	LMW
REVIEWED BY:	JYY
CHECKED BY:	JYY
PROJECT NUMBER:	50160159

1737 AVON STREET EXT CHARLOTTESVILLE, VA 22902


SHEET TITLE


GENERAL NOTES

SHEET NUMBER

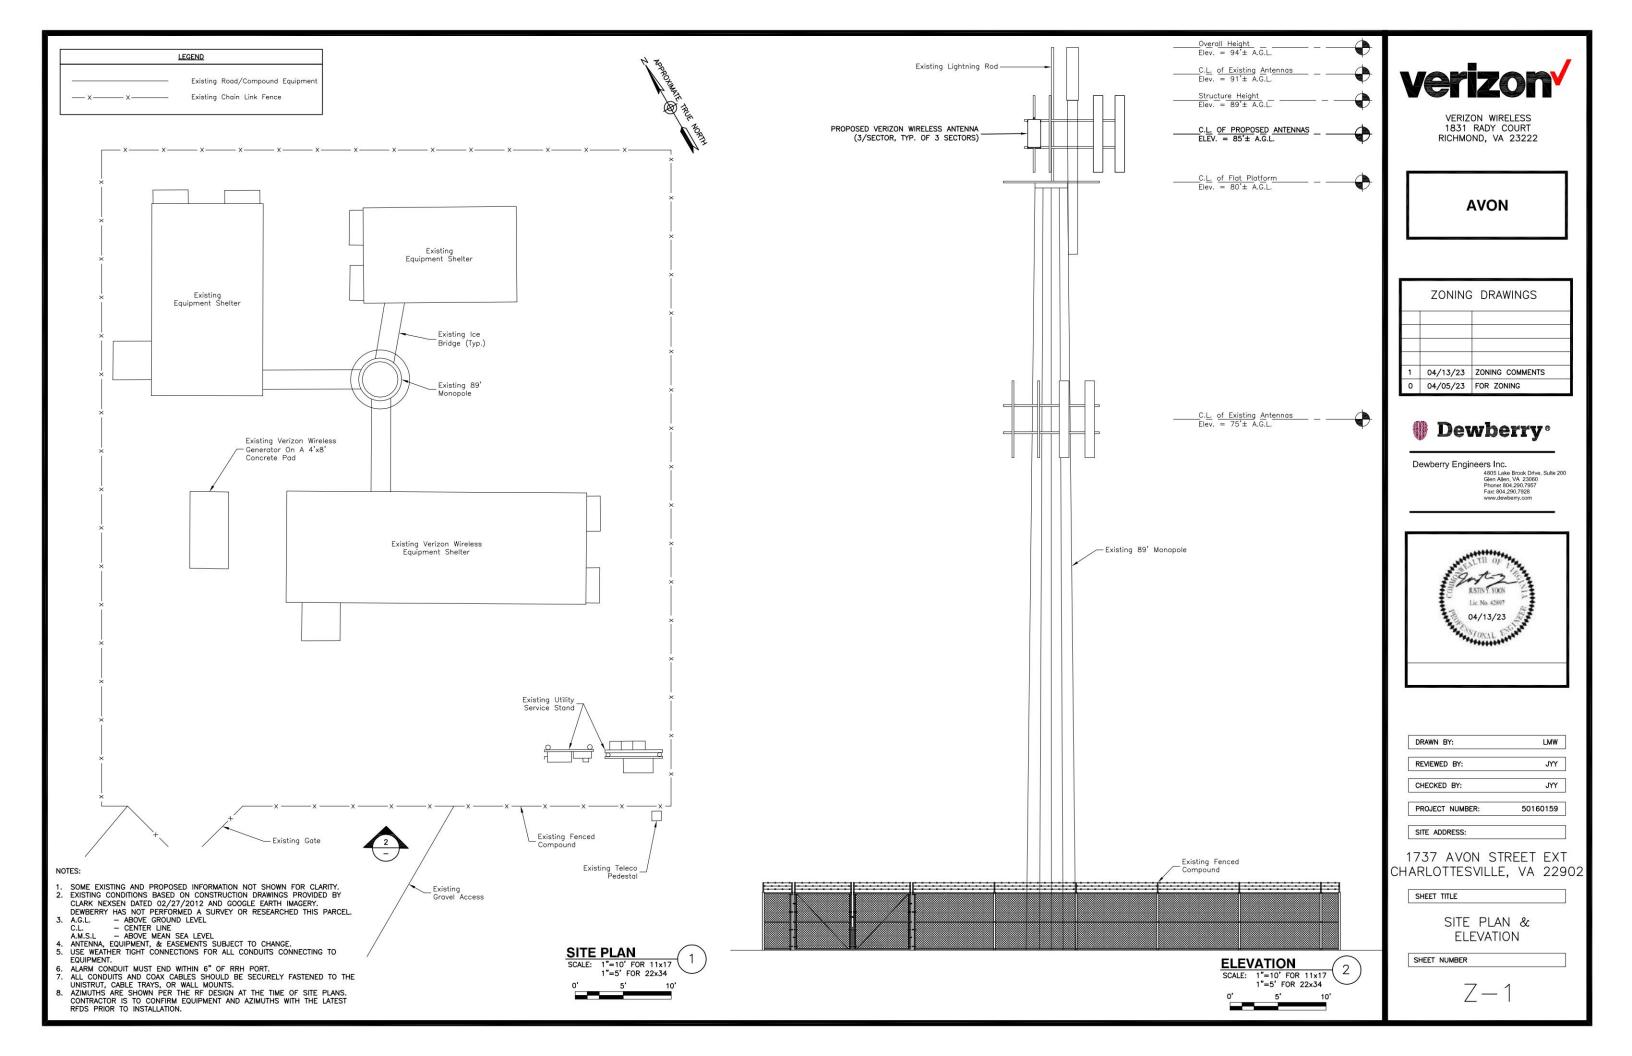



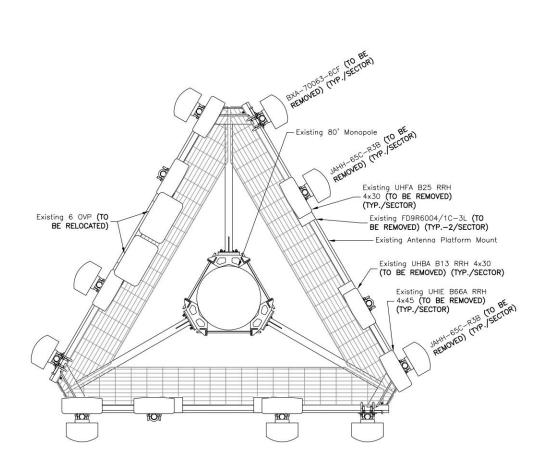

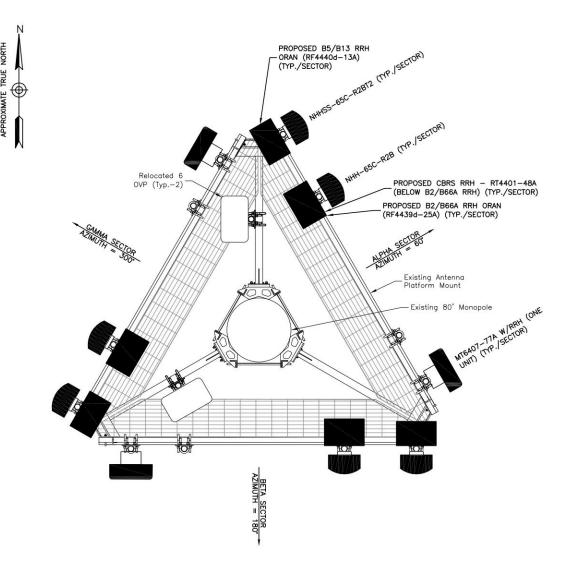

EXISTING ANTENNA MOUNT DETAIL

NOTE: EXISTING EQUIPMENT LAYOUT BASED ON MOUNT MAPPING REPORT BY TOWER ENGINEERING SOLUTIONS LLC DATED 10/07/2022, IN CONJUNCTION WITH LATEST VERIZON

WIRCLESS RFDS.
PROPOSED EQUIPMENT LAYOUT BASED ON MOUNT
ANALYSIS PREPARED BY TOWER ENGINEERING SOLUTIONS
LLC DATED 03/30/23, IN CONJUNCTION WITH LATEST VERIZON WIRELESS RFDS.

PROPOSED ANTENNA MOUNT DETAIL

EQUIPMENT SCHEDULE

1. SOME EXISTING AND PROPOSED INFORMATION NOT SHOWN FO

- CLARITY.

 2. A.G.L.
 C.L.
 A.M.S.L
- CLARITY.

 A.G.L. ABOVE GROUND LEVEL
 C.L. CENTER LINE
 A.M.S.L ABOVE MEAN SEA LEVEL
 ANTENNA, EQUIPMENT, & EASEMENTS SUBJECT TO CHANGE.
 USE WEATHER TIGHT CONNECTIONS FOR ALL CONDUITS
 CONNECTING TO EQUIPMENT.
- CONNECTING TO EQUIPMENT.

 5. ALARM CONDUIT MUST END WITHIN 6" OF RRH PORT.

 6. ALL CONDUITS AND COAX CABLES SHOULD BE SECURELY FASTENED TO THE UNISTRUT, CABLE TRAYS, OR WALL MOUNTS.

 7. AZIMUTHS ARE SHOWN PER THE RF DESIGN AT THE TIME OF SITE PLANS. CONTRACTOR IS TO CONFIRM EQUIPMENT AND AZIMUTHS WITH THE LATEST RFDS PRIOR TO INSTALLATION.

	EXI	STING		PROPOSED			FINAL		
	QTY	RAD C/L	ANTENNA MODEL #	QTY	RAD C/L	ANTENNA MODEL #	QTY	RAD C/L	ANTENNA MODEL #
	3	80'-0"	BXA-70063-6CF (TO BE REMOVED)	3	85'-0"	NHH-65C-R2B	3	85'-0"	NHH-65C-R2B
R [6	80'-0"	JAHH-65C-R3B (TO BE REMOVED)	3	85'-0"	NHHSS-65C-R2BT2	3	85'-0"	NHHSS-65C-R2BT2
	3	80'-0"	UHBA B13 RRH 4x30 (TO BE REMOVED)	3	85'-0"	MT6407-77A W/RRH (ONE UNIT)	3	85'-0"	MT6407-77A W/RRH (ONE UNIT)
	3	80'-0"	UHFA B25 RRH 4x30 (TO BE REMOVED)	3	85'-0"	B2/B66A RRH ORAN (RF4439d-25A)	3	85'-0"	B2/B66A RRH ORAN (RF4439d-25A)
	3	80'-0"	UHIE B66A RRH 4X45 (TO BE REMOVED)	3	85'-0"	B5/B13 RRH ORAN (RF4440d-13A)	3	85'-0"	B5/B13 RRH ORAN (RF4440d-13A)
	12	80'-0"	1-5/8" Coax (TO BE REMOVED)	3	85'-0"	CBRS RRH - RT4401-48A	3	85'-0"	CBRS RRH - RT4401-48A
	6	80'-0"	FD9R6004/1C-3L (TO BE REMOVED)				2	85'-0"	6x12 HYBRIFLEX
S. [2	80'-0"	6x12 Hybriflex (TO REMAIN)				2	85'-0"	6 OVP
	2	80'-0"	6 OVP (TO BE RELOCATED)						



VERIZON WIRELESS 1831 RADY COURT RICHMOND, VA 23222

AVON

	ZONING	DRAWINGS
1	04/13/23	ZONING COMMENTS
0	04/05/23	FOR ZONING

Dewberry*

Dewberry Engineers Inc. 4805 Lake Brook Drive, Suite 200 Glen Allen, VA 23060 Phone: 804.290.7957 Fax: 804.290.7928 www.dewberry.com



DRAWN BY:	LMW
REVIEWED BY:	JYY
CHECKED BY:	JYY
PROJECT NUMBER:	50160159


1737 AVON STREET EXT CHARLOTTESVILLE, VA 22902


SHEET TITLE

EXISTING & PROPOSED ANTENNA CONFIGURATION


SHEET NUMBER

Z-2

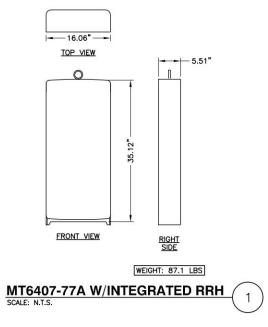

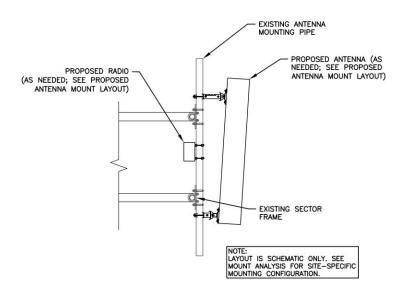

PROPOSED EQUIPMENT MOUNTING DETAIL
SCALE: N.T.S.

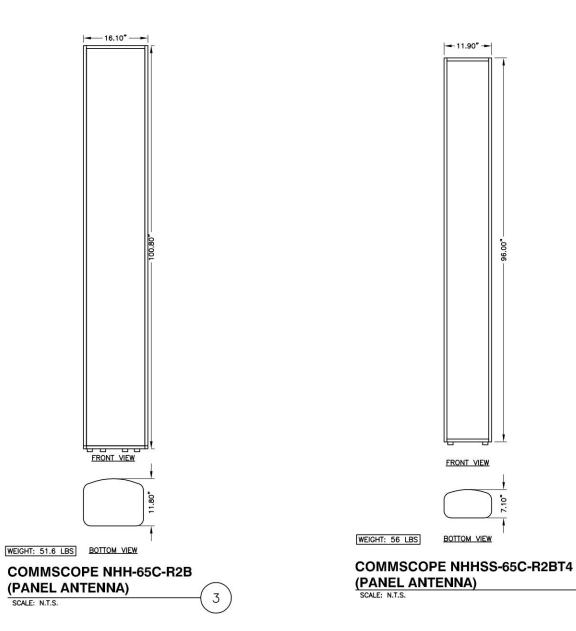

verizon /

VERIZON WIRELESS 1831 RADY COURT RICHMOND, VA 23222

AVON

	ZONING	DRAWINGS
1	04/13/23	ZONING COMMENTS
0	04/05/23	FOR ZONING



Dewberry Engineers Inc.

4805 Lake Brook Drive, Sulte 200
Glen Allen, VA 23060
Phone: 804.290.7957
Fax: 804.290.7928
www.dewbery.com



DRAWN BY:	LMW
REVIEWED BY:	JYY
CHECKED BY:	JYY
PROJECT NUMBER:	50160159


1737 AVON STREET EXT CHARLOTTESVILLE, VA 22902


SHEET TITLE


EQUIPMENT DETAILS


SHEET NUMBER


C - 3

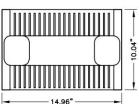

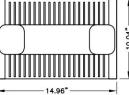

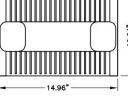


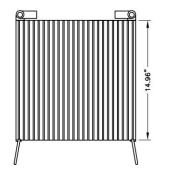


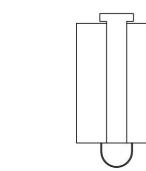


WEIGHT: 74.7 LBS

SAMSUNG B2/B66A RRH ORAN (RF4439d-25A) (SCALE: N.T.S.

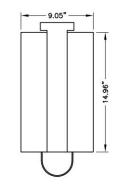


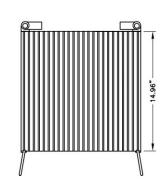

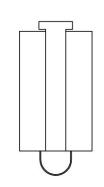

WEIGHT: 70.3 LBS

SAMSUNG B5/B13 RRH ORAN (RF4440d-13A) SCALE: N.T.S.

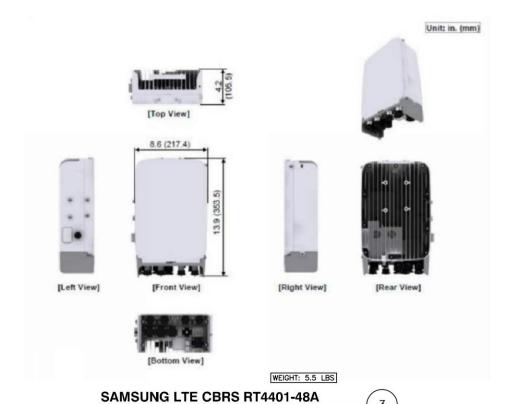




VERIZON WIRELESS 1831 RADY COURT RICHMOND, VA 23222

AVON

	ZONING	DRAWINGS
1	04/13/23	ZONING COMMENTS
0	04/05/23	FOR ZONING



Dewberry Engineers Inc. 4805 Lake Brook Drive, Sulte 200 Glen Allen, VA 23060 Phone: 804.290.7957 Fax: 804.290.7928 www.dewberry.com

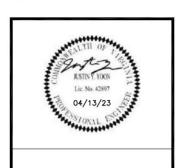

DRAWN BY:	LMW
REVIEWED BY:	JYY
CHECKED BY:	JYY
PROJECT NUMBER:	50160159

1737 AVON STREET EXT CHARLOTTESVILLE, VA 22902

SHEET TITLE

EQUIPMENT DETAILS

SHEET NUMBER

C-4