



SMARTSKY SITE NUMBER: VA107A

SMARTSKY SITE NAME: FEATHERSTONE

SITE TYPE: MONOPOLE

TOWER HEIGHT: 98'-6"

CROWN CASTLE BU #: 842586

SITE ADDRESS: 5722 WYANT LANE  
CHARLOTTESVILLE, VA 22903

COUNTY: ALBEMARLE

JURISDICTION: ALBEMARLE COUNTY

SMARTSKY FIRST TIME INSTALL

SITE INFORMATION

CROWN CASTLE SITE NAME: FEATHERSTONE

SITE ADDRESS: 5722 WYANT LANE  
CHARLOTTESVILLE, VA 22903

COUNTY: ALBEMARLE

MAP/PARCEL #: 07200-00-00-02100

AREA OF CONSTRUCTION: EXISTING

LATITUDE: 38° 1' 59.0"

LONGITUDE: -78° 41' 27.3"

LAT/LONG TYPE: NAD83

GROUND ELEVATION: 680.0 FT

CURRENT ZONING: N/A

JURISDICTION: ALBEMARLE COUNTY

OCCUPANCY CLASSIFICATION: U

TYPE OF CONSTRUCTION: VB

A.D.A. COMPLIANCE: FACILITY IS UNMANNED AND NOT FOR  
HUMAN HABITATION

PROPERTY OWNER: LAWRENCE DAMON HOWELL  
ZURICHSTRASSE 94  
8700 KUSNACHT SWITZERLAND

TOWER OWNER: CCATT LLC  
2000 CORPORATE DRIVE  
CANONSBURG, PA 15317

CARRIER/APPLICANT: SMARTSKY  
4690 FIRST FLIGHT DRIVE  
CHARLOTTE, NC 28208

CROWN CASTLE  
APPLICATION ID: 368309

ELECTRIC PROVIDER: DOMINION POWER  
(866) 366-4357

TELCO PROVIDER: UNKNOWN

PROJECT TEAM

CROWN CASTLE A&E FIRM:  
CROWN CASTLE  
2000 CORPORATE DRIVE  
CANONSBURG, PA 15317  
CROWNAE.APPROVAL@CROWNCastle.COM

CROWN CASTLE CONTACTS:  
3530 TORINGDON WAY, SUITE 300  
CHARLOTTE, NC 28277

MIKE CHIRICO - PROJECT MANAGER  
(919) 386-9514  
BLAINE BROWN - CONSTRUCTION MANAGER  
(703) 819-1080  
AMANDA BROWN - A&E PROJECT MANAGER  
AMANDA.BROWN@CROWNCastle.COM  
(704) 405-6575

SMARTSKY CONTACT:  
TAMMY WEST - PROGRAM MANAGER  
(954) 261-9040

DRAWING INDEX

SHEET #	SHEET DESCRIPTION
T-1	TITLE SHEET
T-2	GENERAL NOTES
C-1	SITE PLAN & TOWER ELEVATION
C-2	ANTENNA PLANS AND SCHEMATIC
C-3	DETAILS
C-4	DETAILS
C-5	DETAILS
E-1	ELECTRICAL SCHEMATIC
G-1	GROUNDING DETAILS
G-2	GROUNDING DETAILS
G-3	GROUNDING DETAILS

ALL DRAWINGS CONTAINED HEREIN ARE FORMATTED FOR FULL SIZE. CONTRACTOR SHALL VERIFY ALL PLANS AND EXISTING DIMENSIONS AND CONDITIONS ON THE JOB SITE AND SHALL IMMEDIATELY NOTIFY THE ENGINEER IN WRITING OF ANY DISCREPANCIES BEFORE PROCEEDING WITH THE WORK OR BE RESPONSIBLE FOR SAME.

PROJECT DESCRIPTION

THE PURPOSE OF THIS PROJECT IS TO ENHANCE BROADBAND CONNECTIVITY AND CAPACITY TO THE EXISTING ELIGIBLE

TOWER SCOPE OF WORK

- INSTALL (2) SECTOR MOUNTS
- INSTALL (6) PANEL ANTENNAS W/ SURGE PROTECTORS
- INSTALL (6) RRHs
- INSTALL (1) DISTRIBUTION PANEL
- INSTALL (1) 7/8" HYBRID CABLE


GROUND SCOPE OF WORK

- INSTALL NEW ICE BRIDGE
- INSTALL (1) SMARTSKY UTILITY FRAME
- INSTALL (1) SMARTSKY OUTDOOR CABINET ON A NEW 5'-0"x5'-0" CONCRETE PAD
- INSTALL (1) GPS ANTENNA ON CABINET
- INSTALL POWER & FIBER TO CABINET


DESIGN PACKAGE BASED ON THE APPLICATION  
ID: 368309  
REVISION: 3

THE PARTIES ABOVE HEREBY APPROVE AND ACCEPT THESE DOCUMENTS AND AUTHORIZE THE CONTRACTOR TO PROCEED WITH THE CONSTRUCTION DESCRIBED HEREIN. ALL CONSTRUCTION DOCUMENTS ARE SUBJECT TO REVIEW BY THE LOCAL BUILDING DEPARTMENT AND ANY CHANGES AND MODIFICATIONS THEY MAY IMPOSE.

VICINITY MAP

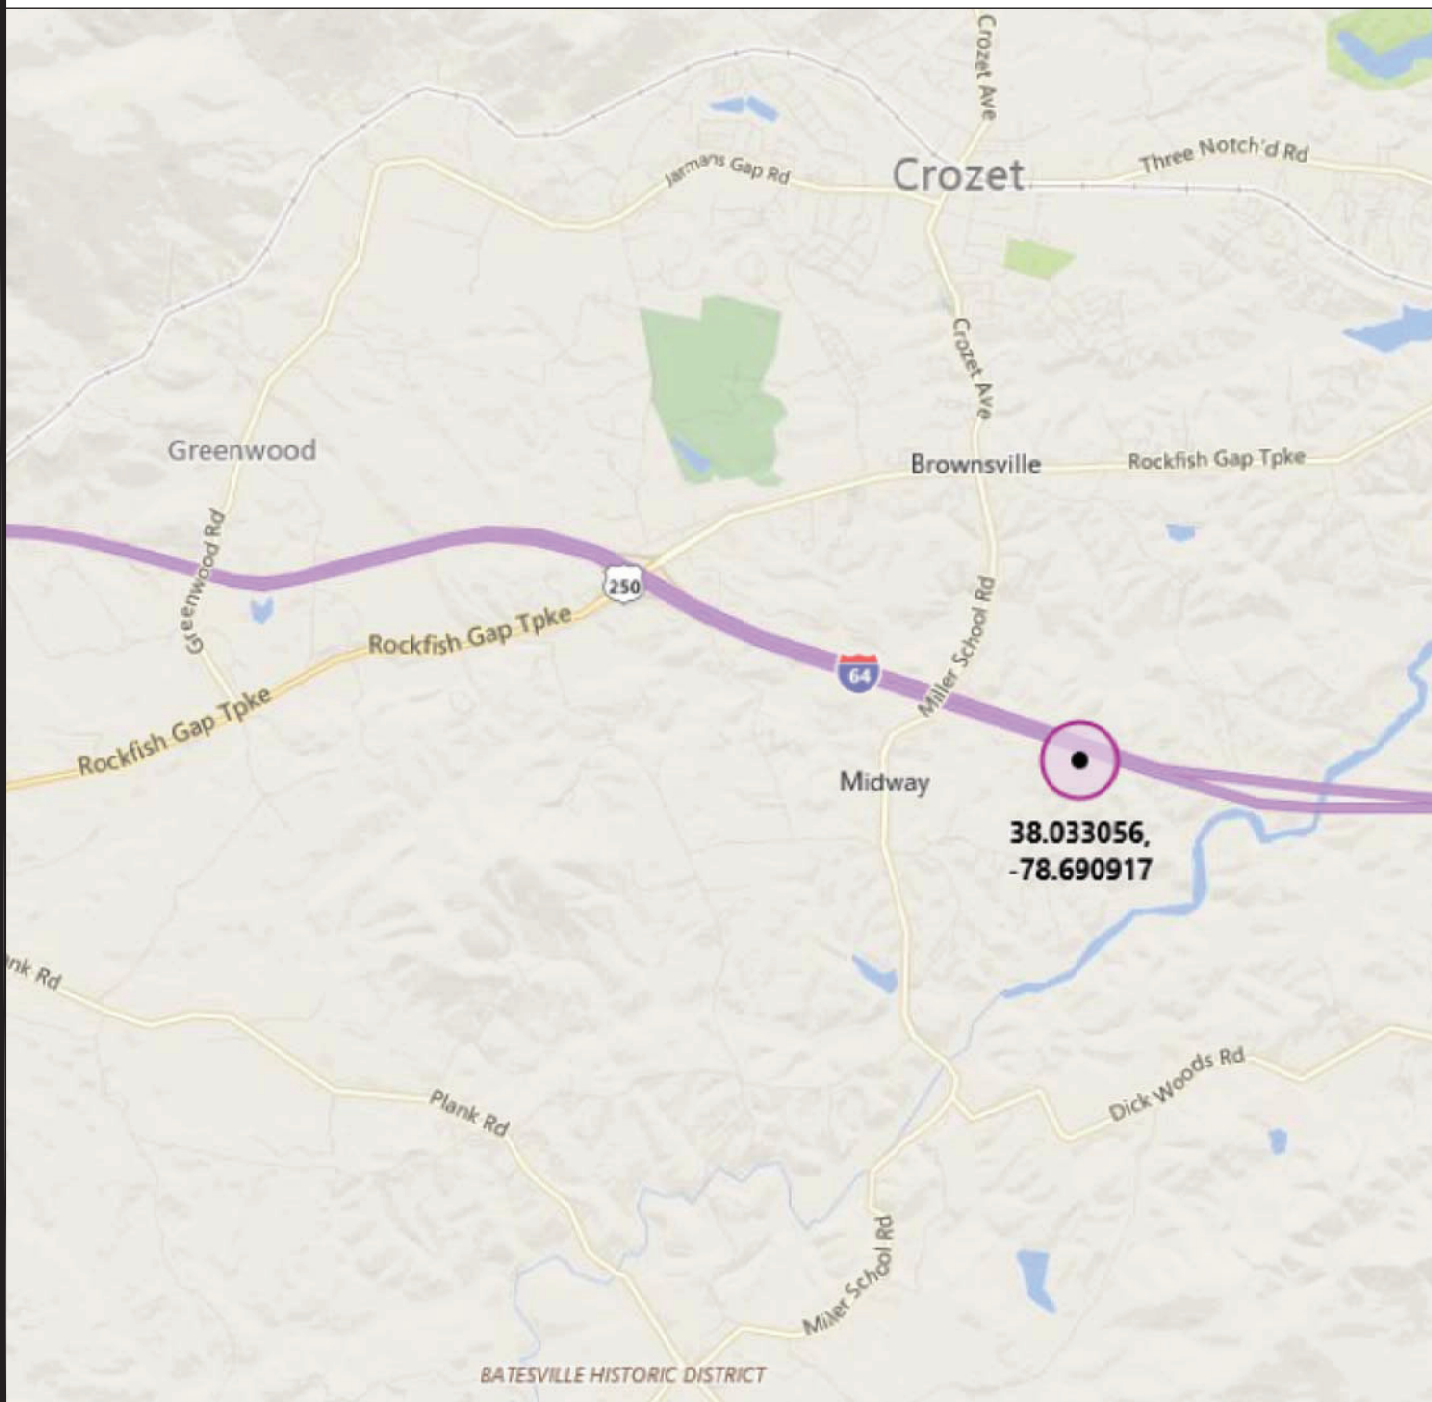

AERIAL MAP

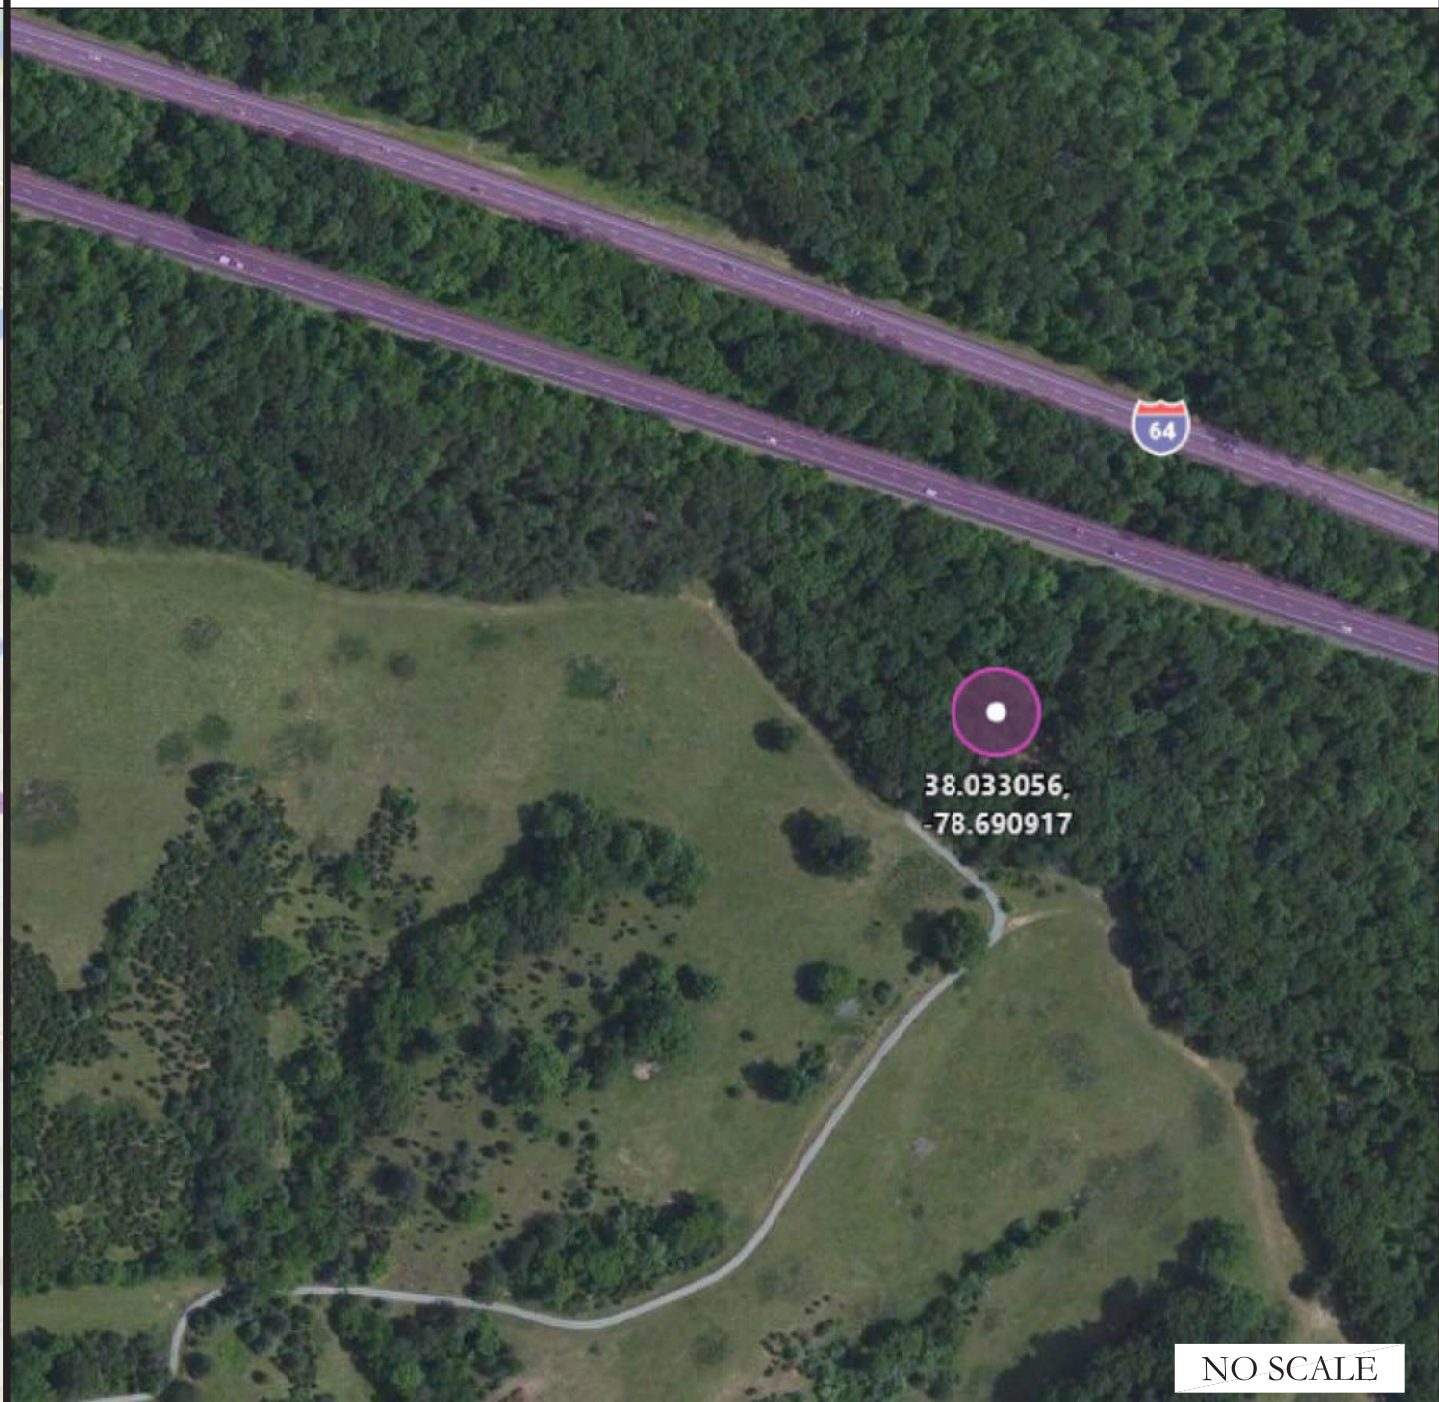

APPLICABLE CODES/REFERENCE DOCUMENTS

ALL WORK SHALL BE PERFORMED AND MATERIALS INSTALLED IN ACCORDANCE WITH THE CURRENT EDITIONS OF THE FOLLOWING CODES AS ADOPTED BY THE LOCAL GOVERNING AUTHORITIES. NOTHING IN THESE PLANS IS TO BE CONSTRUED TO PERMIT WORK NOT CONFORMING TO THESE CODES:

CODE TYPE	CODE
BUILDING	2012 VA CONSTRUCTION CODE/2012 IBC W/ VA AMENDMENTS
MECHANICAL	2012 VA CONSTRUCTION CODE/2012 IMC W/ VA AMENDMENTS
ELECTRICAL	2012 VA CONSTRUCTION CODE/2011 NEC W/ VA AMENDMENTS

REFERENCE DOCUMENTS:

STRUCTURAL ANALYSIS: BY OTHERS

MOUNT ANALYSIS: BY OTHERS

NOTES:

PRIOR TO ACCESSING/ENTERING THE SITE YOU MUST CONTACT THE CROWN NOC AT 800-788-7011 & CROWN CONSTRUCTION MANAGER



CALL VIRGINIA ONE CALL  
(800) 552-7001  
CALL 3 WORKING DAYS  
BEFORE YOU DIG!



4690 FIRST FLIGHT DRIVE  
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BU #: 842586  
FEATHERSTONE

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CHARLOTTESVILLE, VA 22903

EXISTING 98'-6" MONOPOLE

ISSUED FOR:

REV	DATE	DRWN	DESCRIPTION	DES./QA
A	03/31/17	TB	PRELIMINARY	JM

**THIS DOCUMENT IS  
PRELIMINARY IN  
NATURE AND IS NOT A  
FINAL, SIGNED AND  
SEALED DOCUMENT**

Andrew Joseph Fandozzi III, P.E.  
Professional Engineer License: #053839  
Crown Castle USA, Inc. COA #407005050

IT IS A VIOLATION OF LAW FOR ANY PERSON,  
UNLESS THEY ARE ACTING UNDER THE DIRECTION  
OF A LICENSED PROFESSIONAL ENGINEER,  
TO ALTER THIS DOCUMENT.

SHEET NUMBER:

T-1


REVISION:

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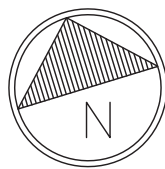


SITE PLAN NOTES:

1. THIS SITE PLAN REPRESENTS THE BEST PRESENT KNOWLEDGE AVAILABLE TO THE ENGINEER AT THE TIME OF THIS DESIGN. THE CONTRACTOR SHALL VISIT THE SITE PRIOR TO CONSTRUCTION AND VERIFY ALL EXISTING CONDITIONS RELATED TO THE SCOPE OF WORK FOR THIS PROJECT.
2. ICE BRIDGE, CABLE LADDER, COAX PORT, AND COAX CABLE ARE SHOWN FOR REFERENCE ONLY. CONTRACTOR SHALL CONFIRM THE EXACT LOCATION OF ALL PROPOSED AND EXISTING EQUIPMENT AND STRUCTURES DEPICTED ON THIS PLAN. BEFORE UTILIZING EXISTING CABLE SUPPORTS, COAX PORTS, INSTALLING NEW PORTS OR ANY OTHER EQUIPMENT, CONTRACTOR SHALL VERIFY ALL ASPECTS OF THE COMPONENTS MEET THE CROWN CASTLE SPECIFICATIONS.
3. IT IS THE RESPONSIBILITY OF THE CONTRACTOR TO COORDINATE WITH THE CROWN CASTLE CONSTRUCTION MANAGER AND LOCAL UTILITY COMPANY FOR THE INSTALLATION OF CONDUITS, CONDUCTORS, BREAKERS, DISCONNECTS, OR ANY OTHER EQUIPMENT REQUIRED FOR ELECTRICAL SERVICE. ALL ELECTRICAL WORK SHALL BE PERFORMED IN ACCORDANCE WITH LATEST EDITION OF THE STATE AND NATIONAL CODES, ORDINANCES AND REGULATIONS APPLICABLE TO THIS PROJECT.
4. USE EXISTING WAVEGUIDE LADDER/MOUNT FOR VERTICAL CABLE RUN WHERE FEASIBLE. COAX ATTACHMENT TO THE TOWER CANNOT BE INSTALLED ON THE CLIMBING LADDER. QUICK TIES ARE NOT AN ACCEPTABLE METHOD OF COAX ATTACHMENT.
5. INSTALLATION OF ICE BRIDGE SHALL NOT OBSTRUCT GPS ANTENNA ON TOP OF CABINET.
6. PULL BOX(S) ARE REQUIRED WHEN THE EQUIVALENT OF FOUR 90 BENDS, INCLUDING THE BENDS LOCATED AT AN OUTLET OR FITTING, ARE USED BETWEEN PULL POINTS; 150 FT OF CONDUIT LENGTH IS EQUIVALENT TO AN ADDITIONAL 90 DEGREES.

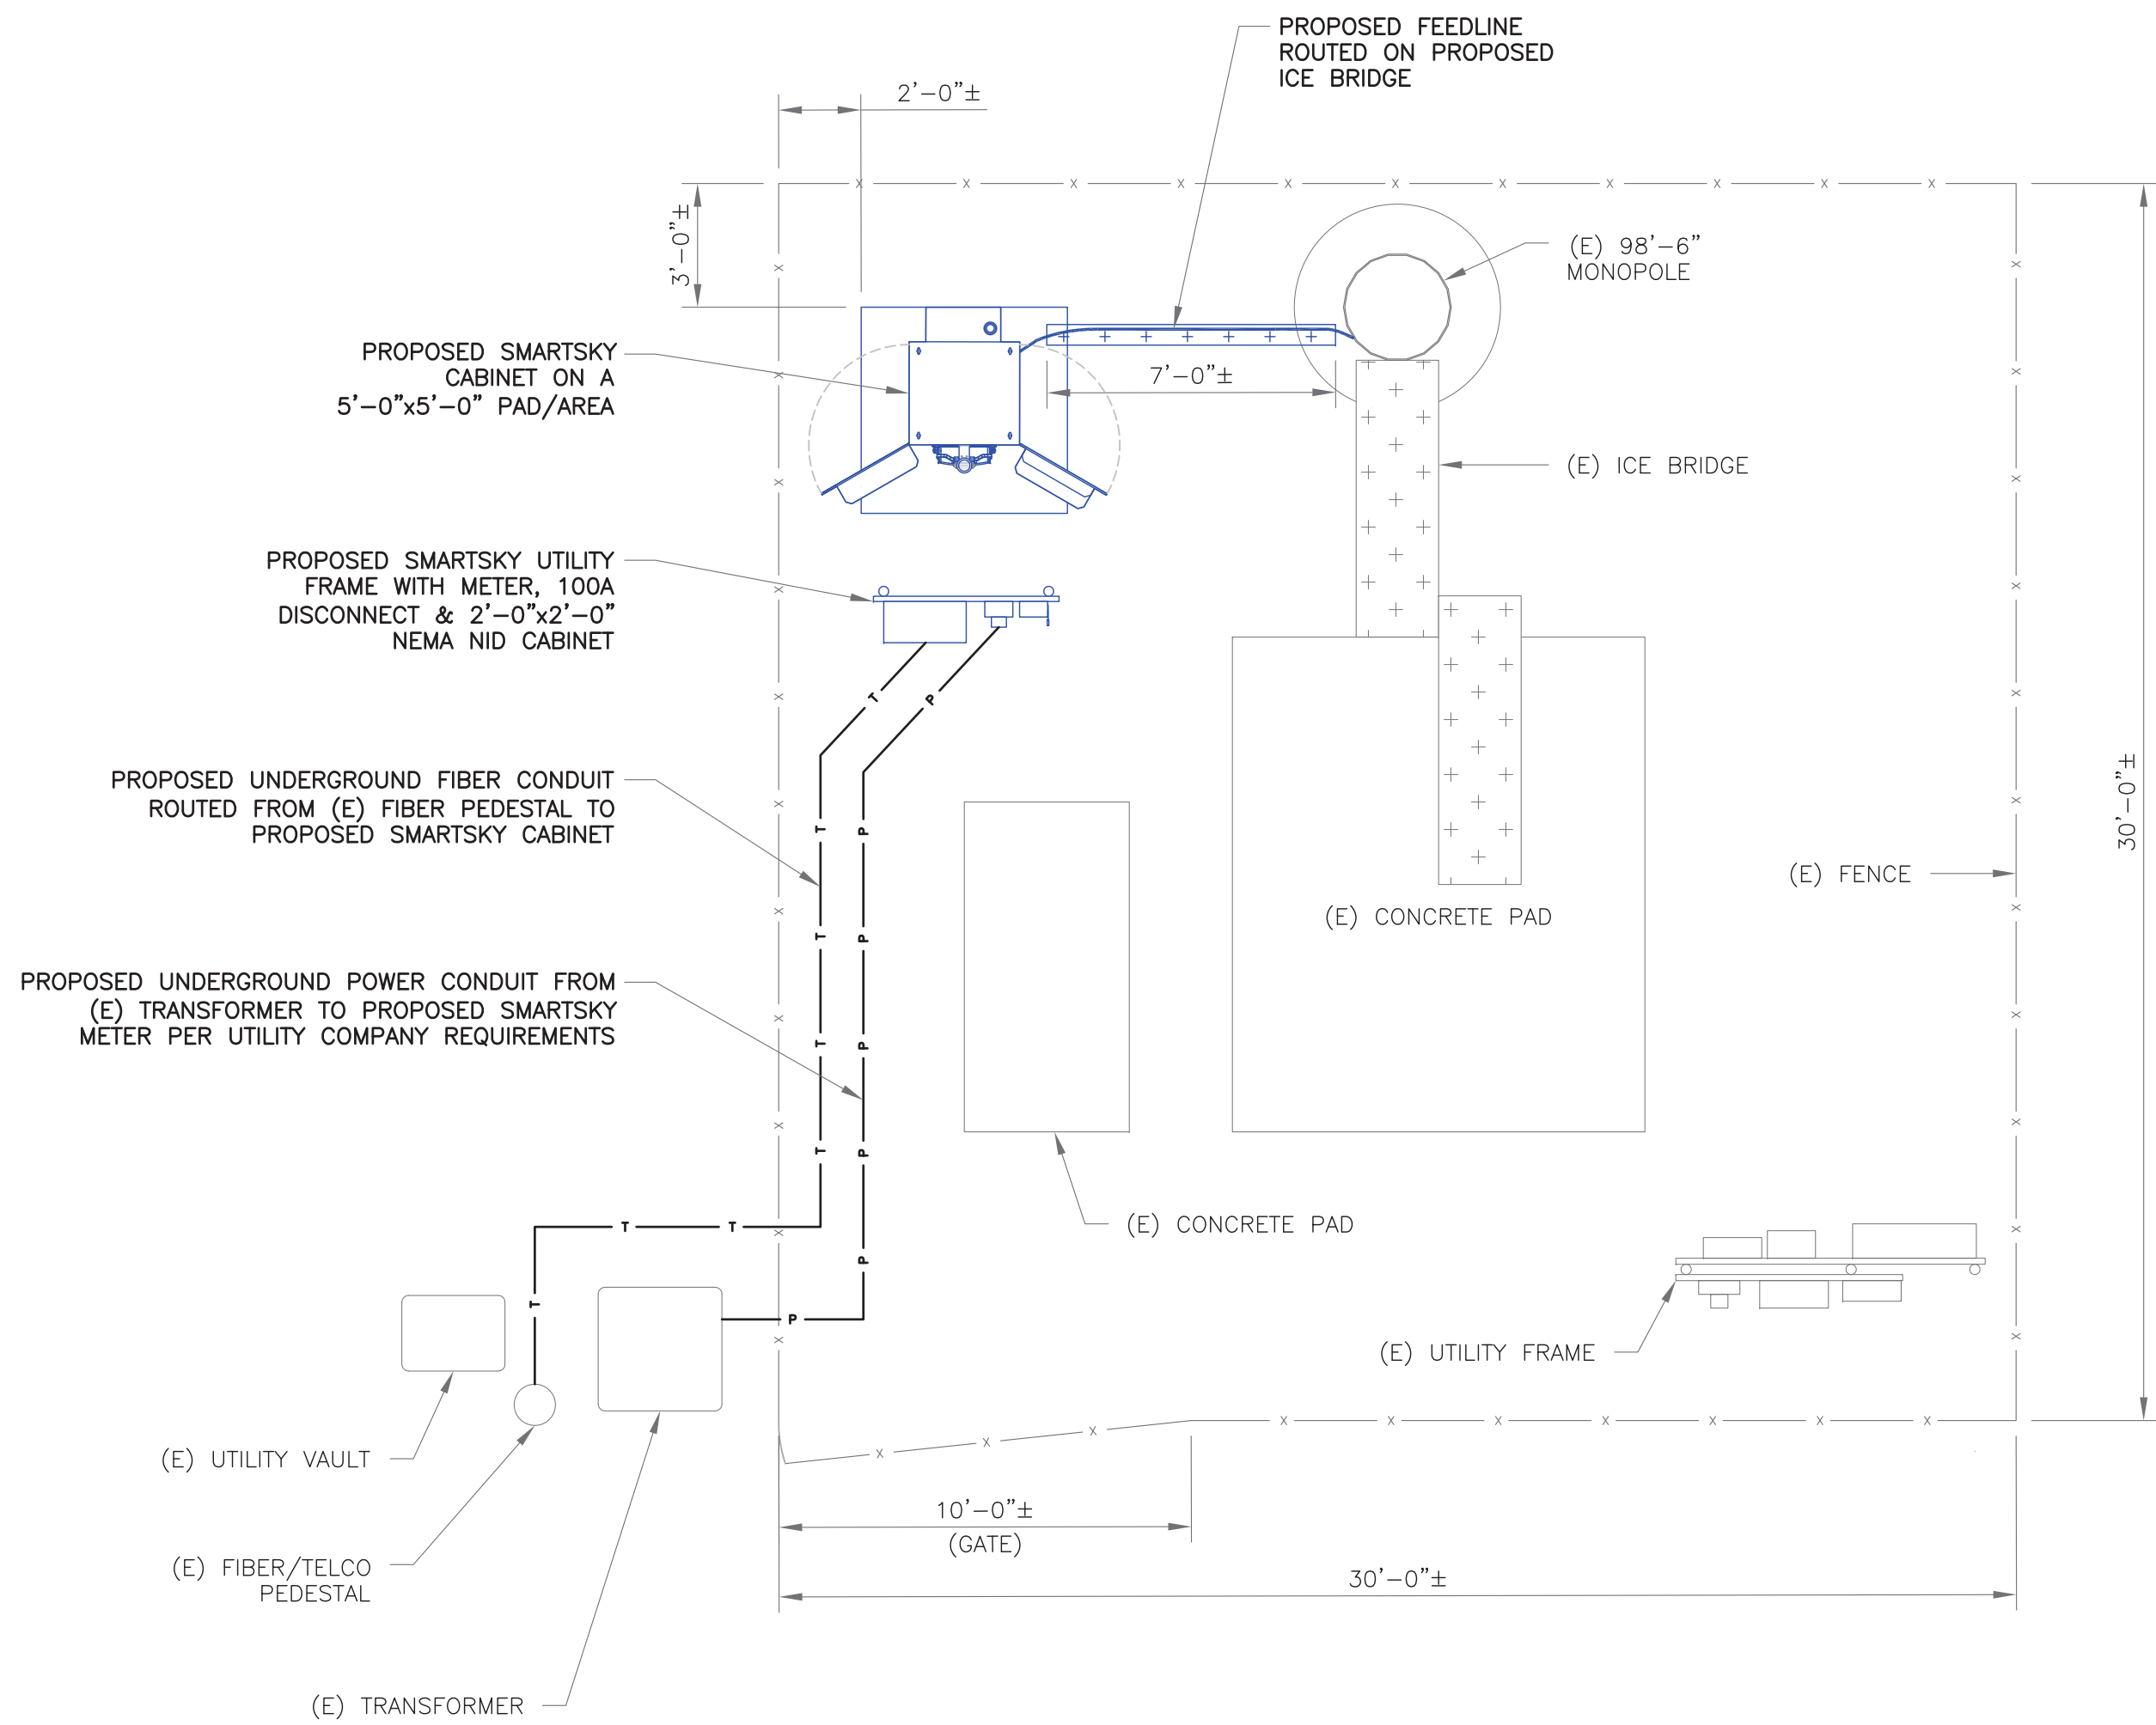


1 SITE PLAN  
SCALE: 1/4"=1'-0" (FULL SIZE)  
1/8"=1'-0" (11x17)



HEIGHT OF STRUCTURE  
ELEV. = 98'-6"

ACROSS FLATS (1'-10")  
ELEV. = 60'-0"

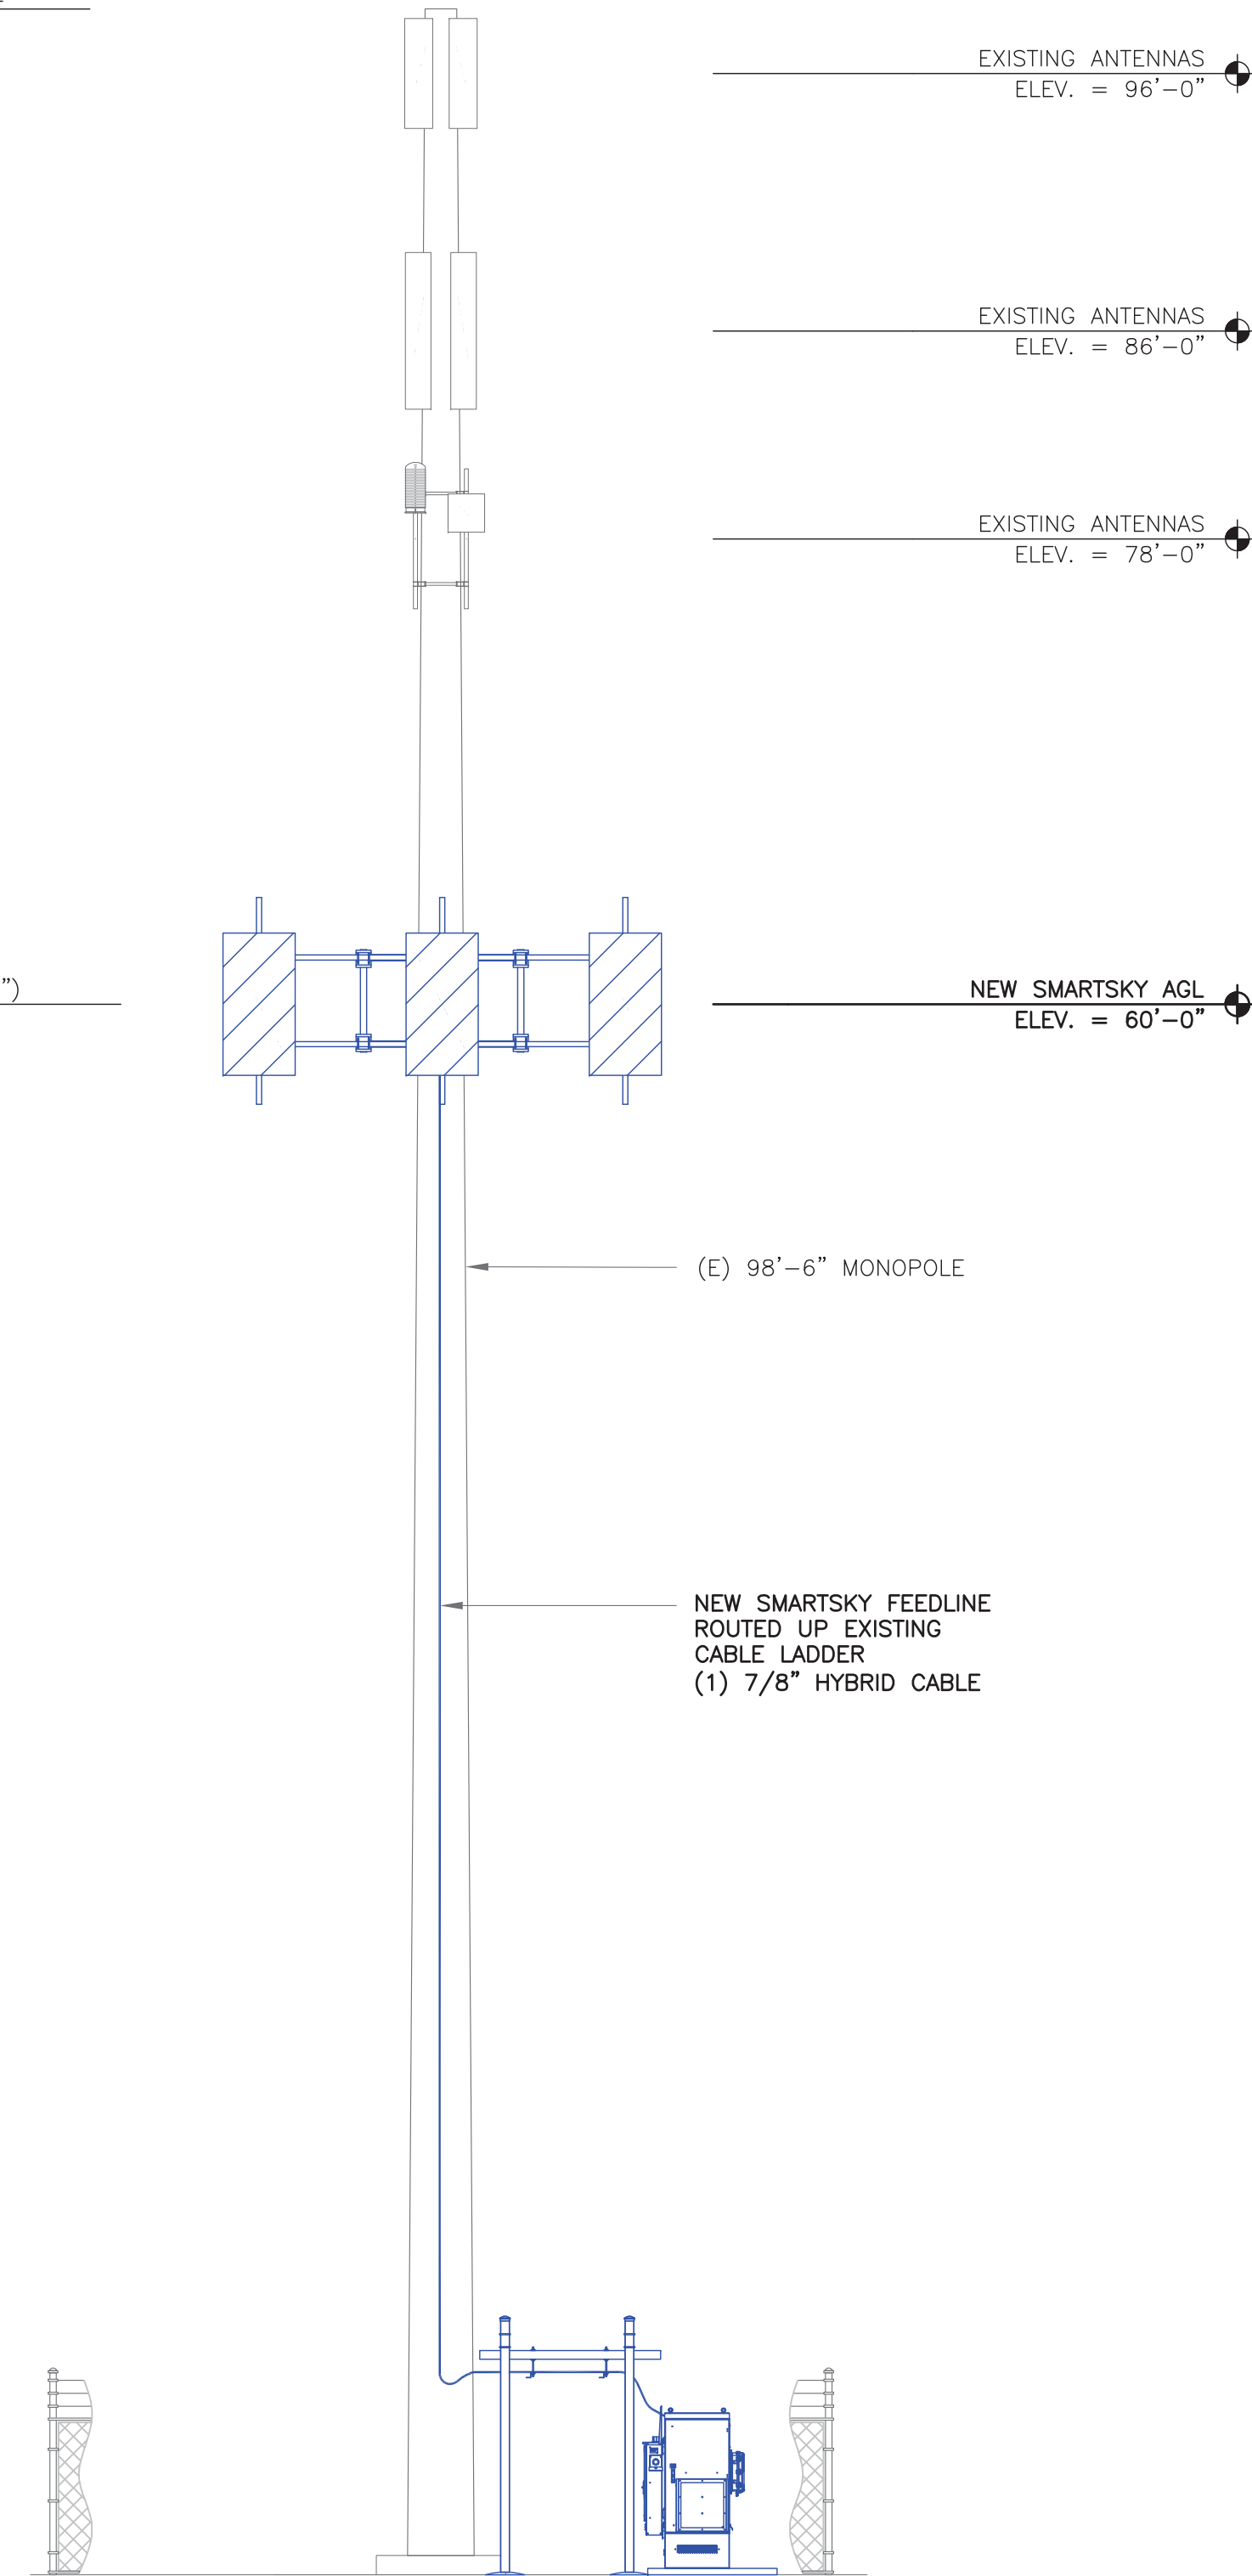

2 TOWER ELEVATION  
SCALE: NOT TO SCALE



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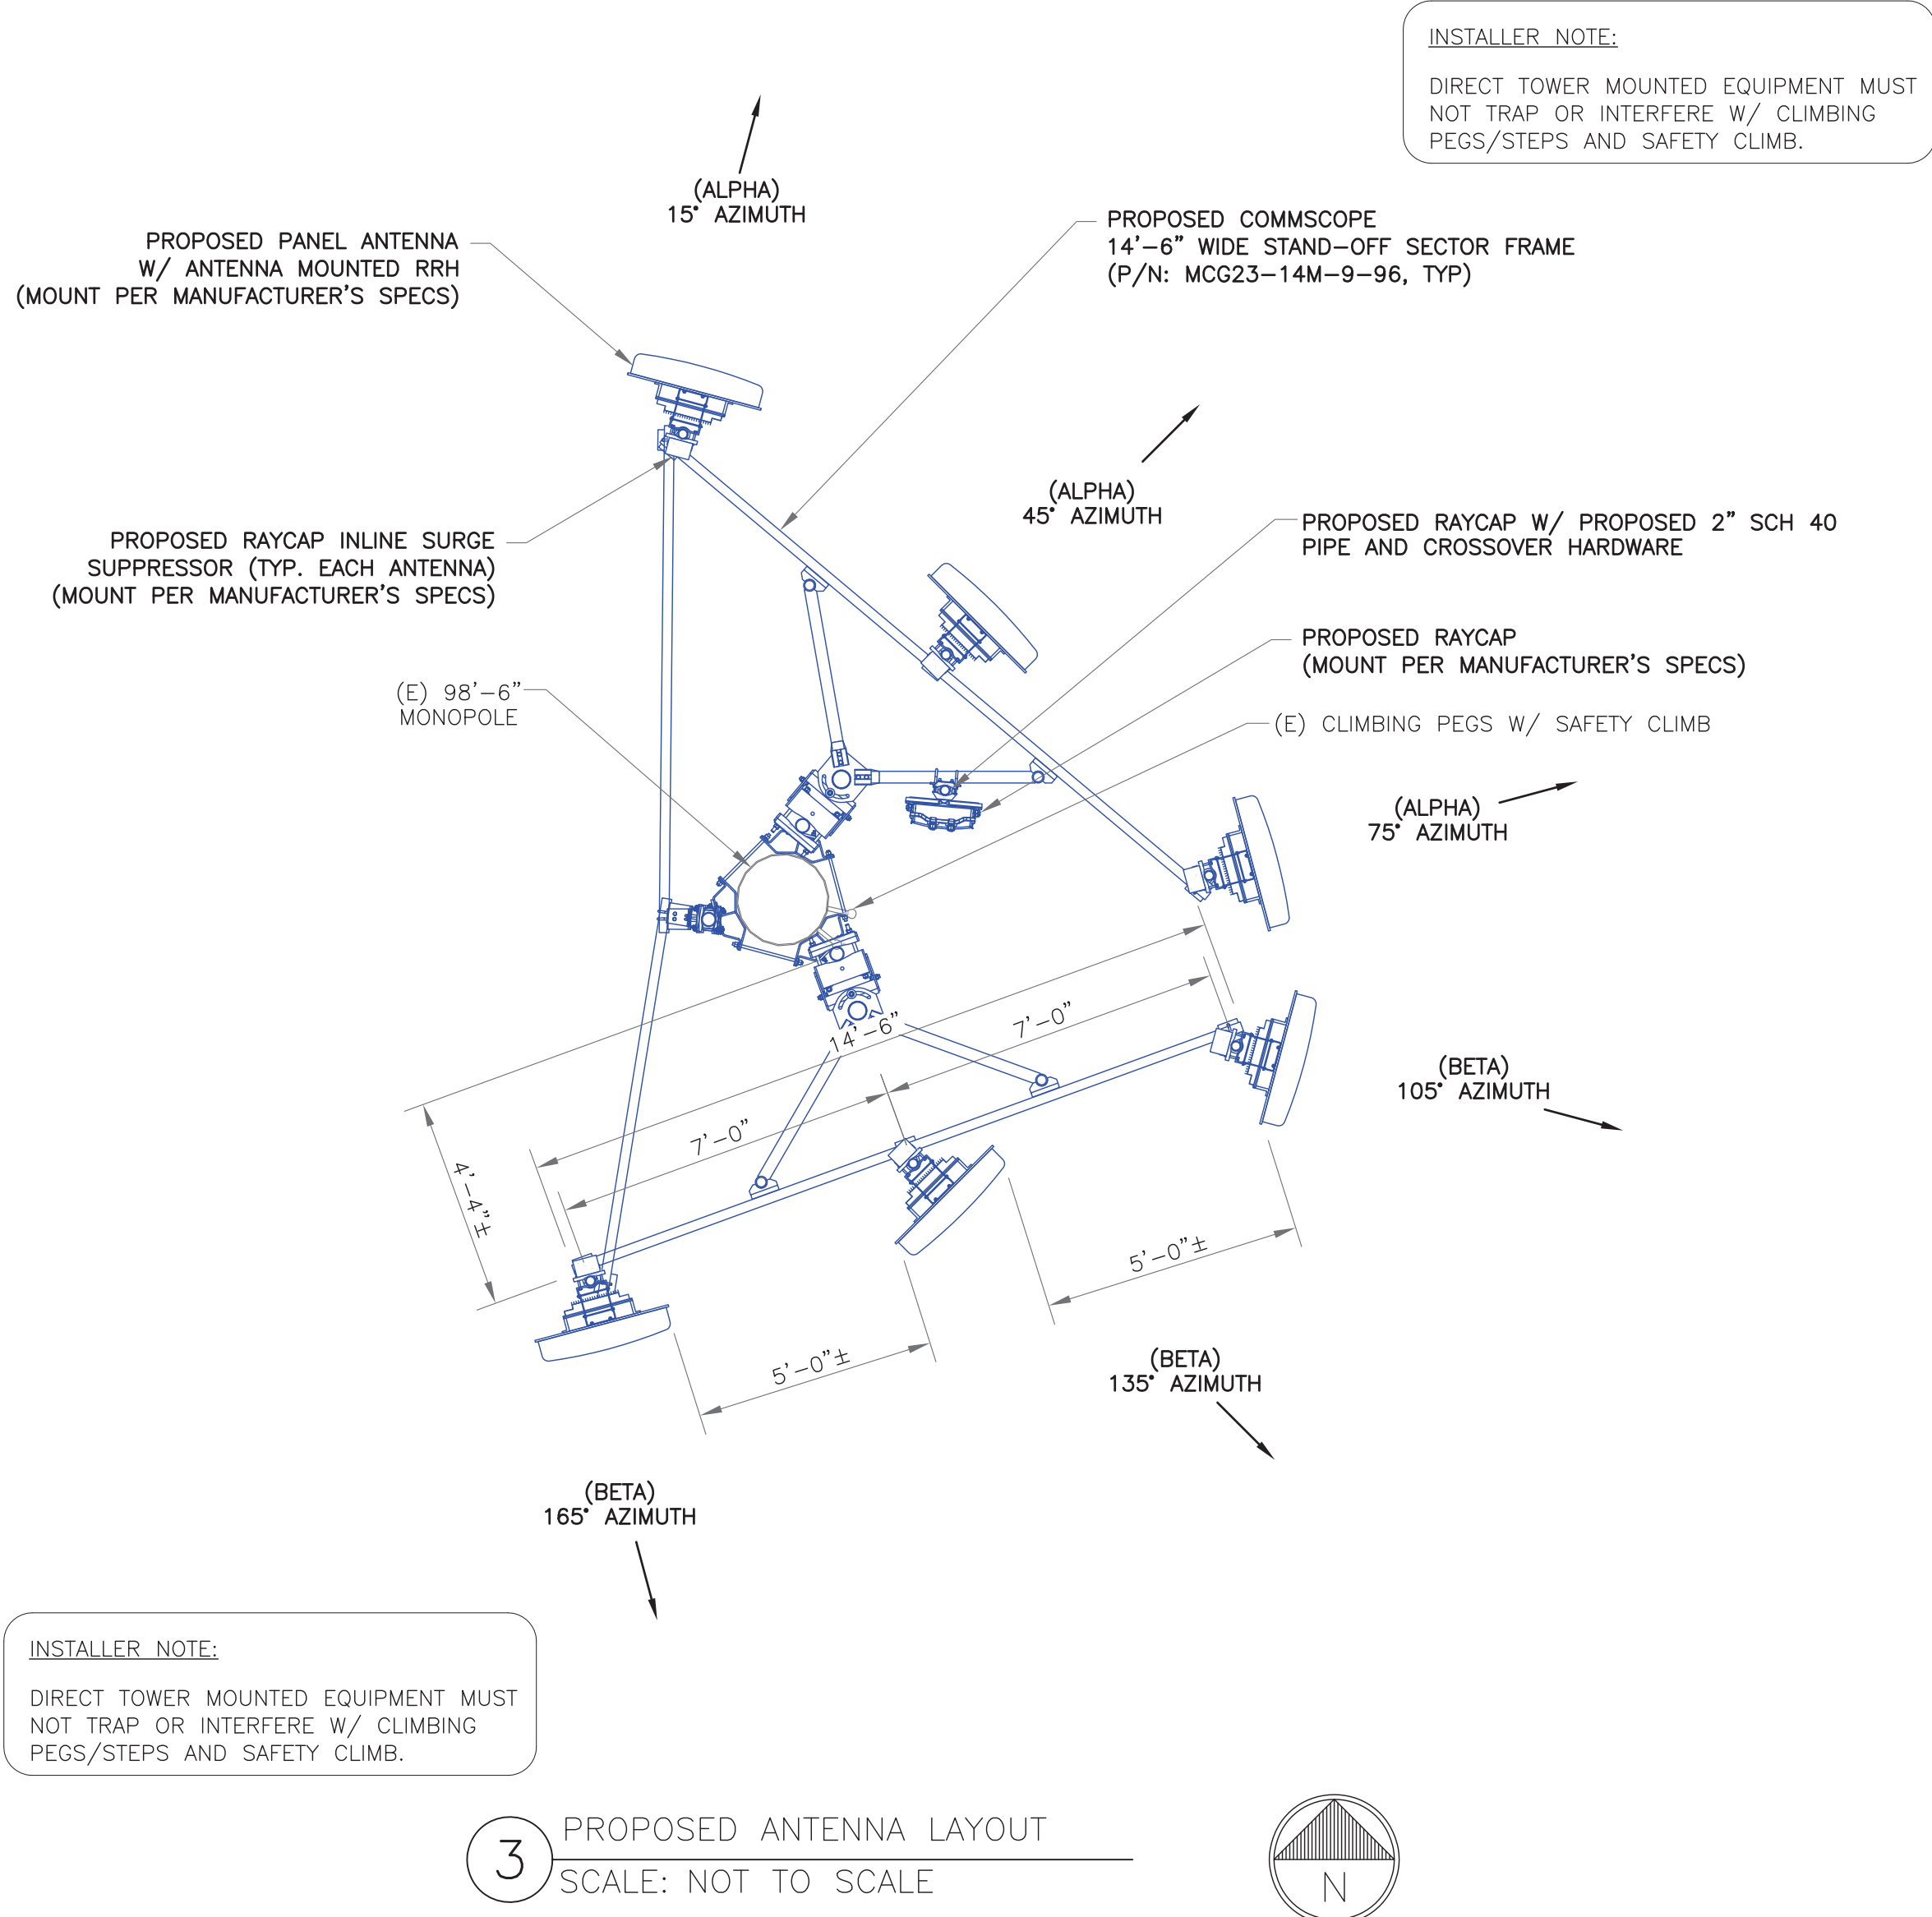
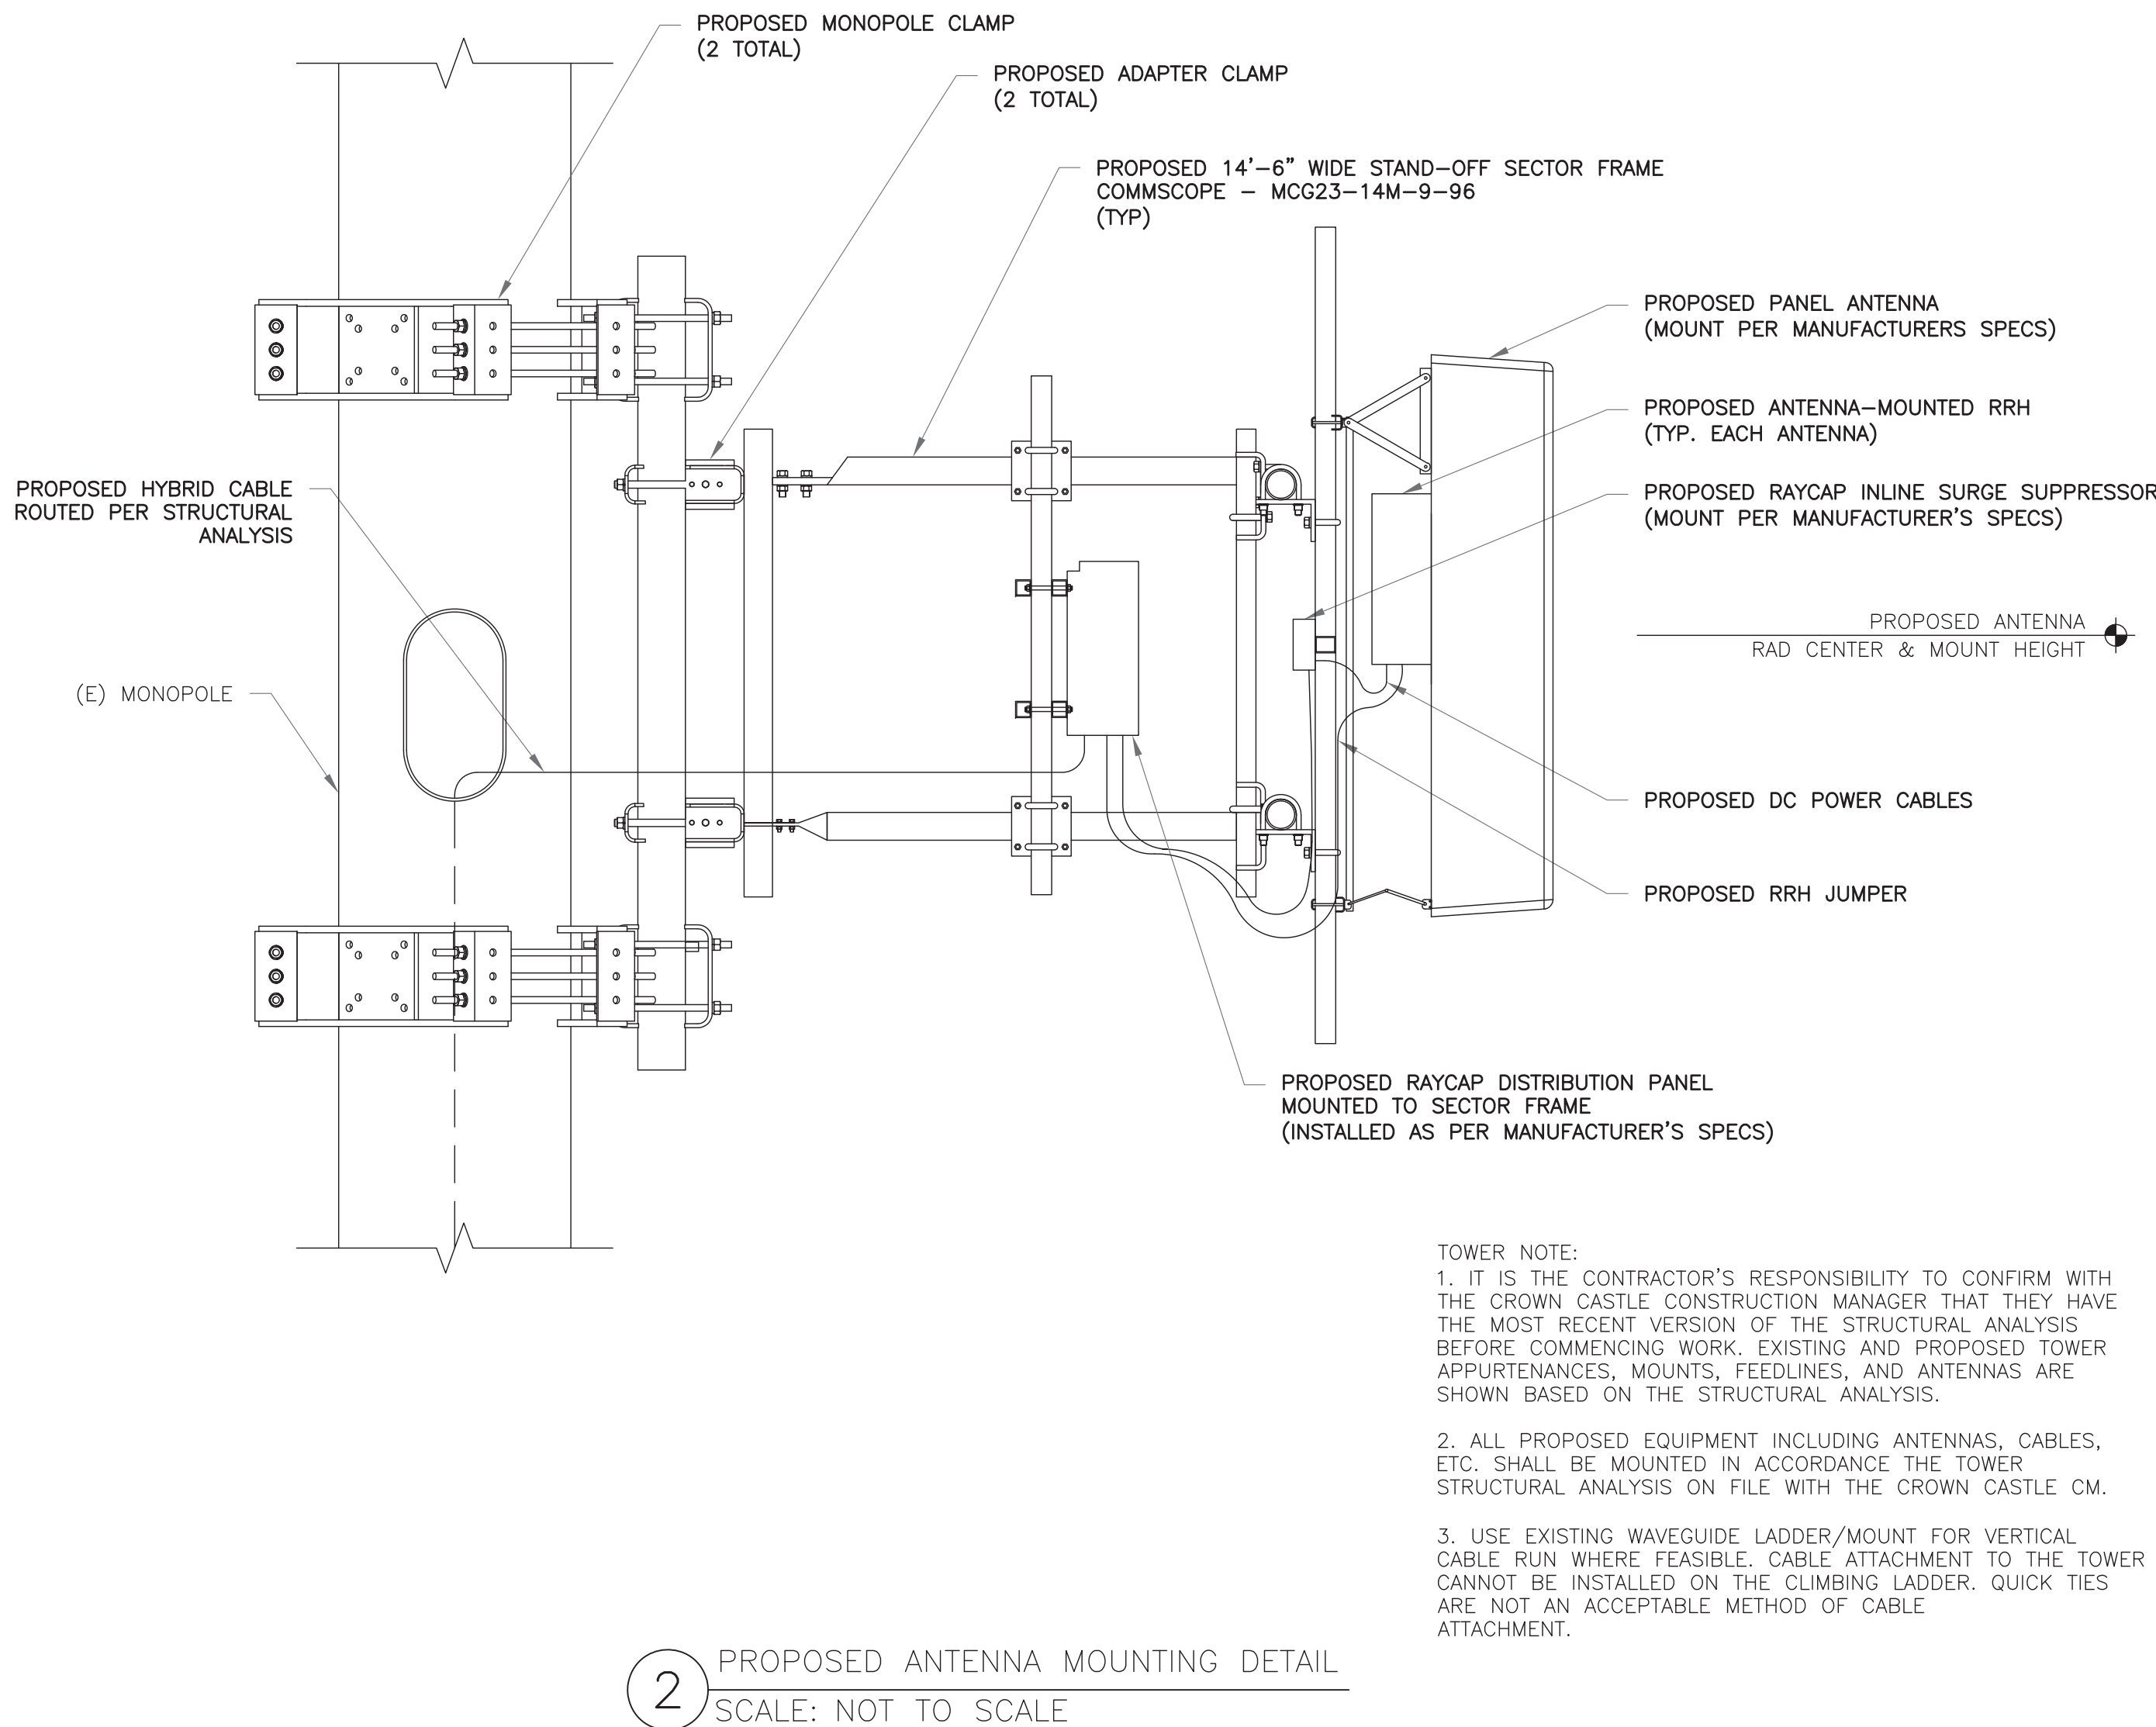
REVISION:

**A**



RF SCHEDULE & B.O.M.									
ITEM	MANUFACTURER	PART NUMBER	SUPPLIER	QUANTITY	LENGTH	RAD CENTER	AZIMUTH (TRUE NORTH)	MECH UP-TILT	COMMENTS
PANEL ANTENNA	CCI ANTENNAS	BFA8F-A5A	CUSTOMER	6	N/A	60'-0"	15'/45'/75'/105'/135'/165'	4.5' UP-TILT	-
RRH	HARRIS	RRH	CUSTOMER	6	N/A	60'-0"	N/A	-	-
DISTRIBUTION PANEL (1390)	RAYCAP	RHDC-1390-PF-48	CUSTOMER	1	N/A	60'-0"	N/A	-	-
RRH DC SURGE SUPPRESSOR (3441)	RAYCAP	RHDC-3441-P-48-NA	CUSTOMER	6	N/A	60'-0"	N/A	-	INLINE DC SURGE SUPPRESSION
HYBRID CABLE (FIBER & POWER)	EUCA HYBRID	78-12C6-24MM5	CUSTOMER	1	120'-0"±	60'-0"	N/A	-	-
FIBER JUMPER (1390 TO RRH)	EUPEN	HF2M900LCFA-A/A	CUSTOMER	6	29' (SEE NOTE 2)	60'-0"	N/A	-	2 FIBERS MULTI-MODE, LC/UPC
DC JUMPER (3441 TO RRH)	CHOGORI	1I200116061701	CUSTOMER	6	15' (SEE NOTE 2)	60'-0"	N/A	-	2x14 AWG CONDUCTORS (B/W)
DC JUMPER (1390 TO 3441)	EUPEN	HP206	CUSTOMER	6	75' (SEE NOTE 2)	N/A	N/A	-	SPOOL OF 75' CUT TO LENGTH ON SITE
1. BASED ON APPROVED CROWN CASTLE APPLICATION DATED 01/26/2017. CONFIRM WITH CROWN CASTLE CONSTRUCTION MANAGER FOR APPLICABLE UPDATES/REVISIONS AND MOST RECENT RFDS. 2. JUMPER AND DC POWER CABLE LENGTH SHOWN REFERS TO SHORTEST PRECUT LENGTH THAT WILL REACH RRH/INLINE SURGE SUPPRESSOR. 3. THE ANTENNAS LISTED IN THIS B.O.M. ARE ONLY USED TO REPRESENT A BASIS OF DESIGN DIMENSIONS FOR THE ANTENNA AND MOUNT ORIENTATION PER THE APPLICATION. THE CUSTOMER WILL PROVIDE ANTENNA MODELS AFTER PRELIMINARY DRAWINGS ARE SUBMITTED. 4. EXCESS COAX TO BE COILED.									

1 RF SCHEDULE  
SCALE: NOT TO SCALE



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