Application for a Special Exception Narrative

Sentara Martha Jefferson Hospital – Early Learning Center

The applicant requests a waiver to the maximum building setback requirements of Section 4.20 of Chapter 18 of the County's Code. Section 4.20 indicates the maximum building setback in a commercial district is 30 feet from the right-of-way. The applicant request no maximum setback be applied to this project.


The proposed building is proposed to be setback between 90'-120' from the right-of-way. This setback is more in line with other buildings within the Peter Jefferson Place development. In addition, a use such as a daycare requires adequate separation between vehicles and play areas for the children. Allowing the parking on the right-of-way side of the building, and thus increasing the buildings setback, allows for the playground to be on the opposite side of the building safely sheltered from the parking lot and roadway.

SENTARA MARTHA JEFFERSON HOSPITAL EARLY LEARNING CENTER

MAJOR SITE PLAN AMENDMENT

ALBEMARLE COUNRY, VIRGINIA

9/15/2023

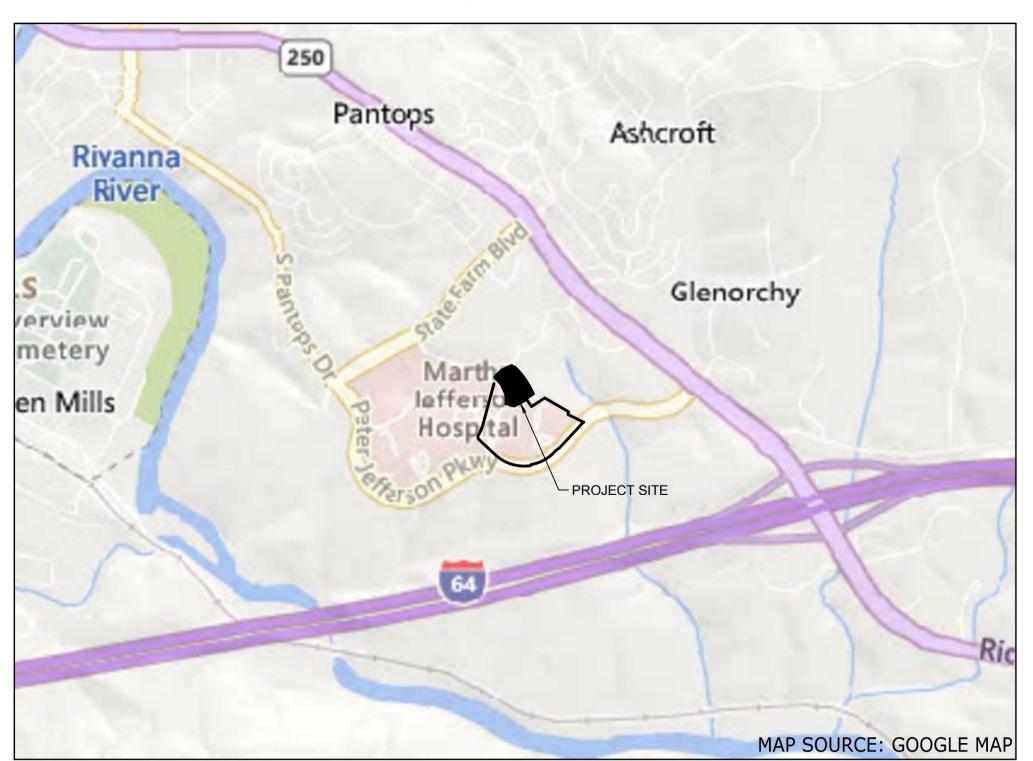


VICINITY MAP

595 MARTHA JEFFERSON DR CHARLOTTESVILLE VA 22911 CONTACT: MICHAEL SPATZ TELEPHONE: (434) 654-7038 EMAIL: MRSPATZ@SENTARA.COM

608 PRESTON AVENUE, SUITE 200 CHARLOTTESVILLE, VA 22903 CONTACT: CAMPBELL BOLTON, P.E.

TELEPHONE: 434-327-1698 EMAIL: CAMPBELL.BOLTON@TIMMONS.COM

TO MARTHA JEFFERSON HEALTH SERVICES OUTPATIENT CARE CENTER (OCC)

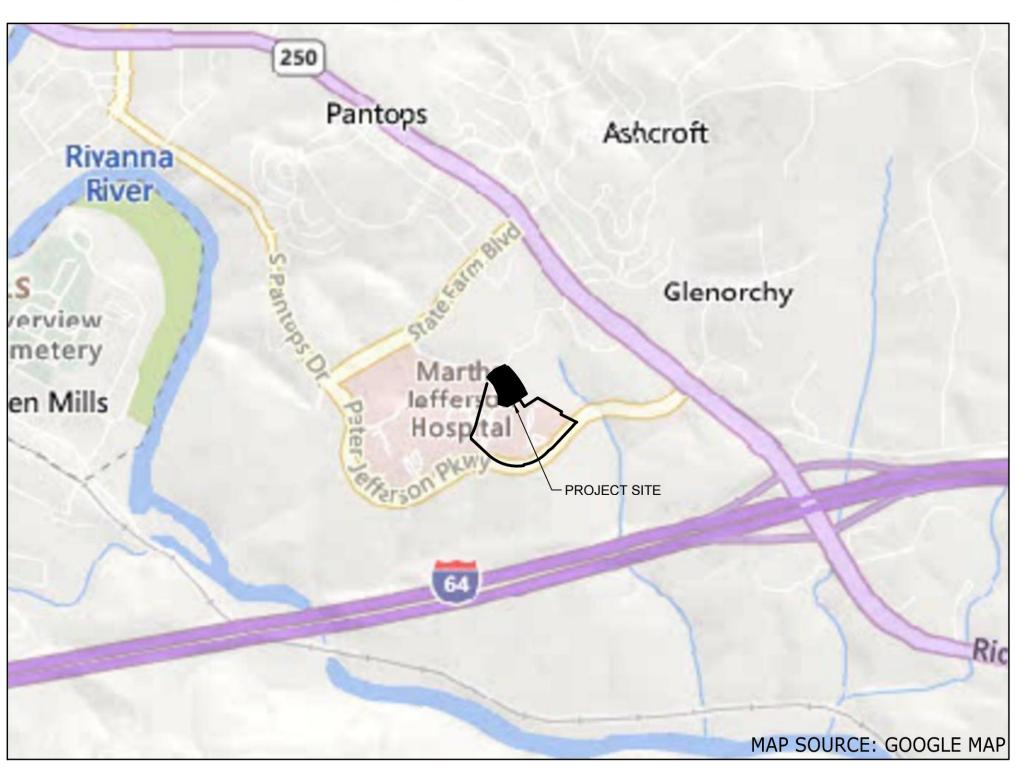

SCALE 1"=1000'

OWNER:

MARTHA JEFFERSON HOSPITAL

ENGINEER OF RECORD:

TIMMONS GROUP

THIS DRAWING PREPARED AT THI
CHARLOTTESVILLE OFFICE
Avenue, Suite 200 | Charlottesvil
5.5624 FAX 434.295.8317 www.t

Sheet List Table

Number

C0.1

C0.2

C0.3 C0.4

C4.1

L3.0

L4.0

Sheet Title

COVER SHEET

GENERAL NOTES

UTILITY PLAN

LANDSCAPE PLAN

LANDSCAPE NOTES AND DETAILS SITE LIGHTING AND PHOTOMETRIC PLAN

LIGHTING CUT SHEET

TOTAL NUMBER OF SHEETS: 19

GRADING AND DRAINAG

09/15/2023 DRAWN BY

.VAN NIEKER DESIGNED BY VAN NIEKERI CHECKED BY

C. BOLTON \simeq

59380 SHEET NO.

C0.0

SITE DATA:

TAX MAP PARCEL AND OWNER INFO:

LIMITS OF DISTURBANCE:

EXISTING ZONING:

OVERLAY DISTRICT:

CURRENT USE:

PROPOSED USE:

MAGISTERIAL DISTRICT:

MAXIMUM BUILDING HEIGHT:

PROPOSED BUILDING HEIGHTS

PROPOSED IMPERVIOUS AREA:

SURVEY CONDUCTED:

WETLAND IMPACTS:

PARKING CALCULATIONS:

SPACES REQUIRED:

DAYCARE:

PARKING PROVIDED:

ADJACENT PARCELS

FLOODPLAIN:

REQUIRED BUILDING SETBACKS:

DATUM:

SOURCE OF SURVEY, BOUNDARY, AND TOPOGRAPHY

120 CHILDREN = 12 SPACES

35 EMPLOYEES = 35 SPACES

73,390 NET SF = 367 SPACES

NEW SPACES = 17 SPACES (INCLUDED 2 ADA SPACES)

EXISTING MEDICAL OFFICE:

TOTAL REQUIRED = 414 SPACES

EXISTING SPACES = 432 SPACES SPACES REMOVED = 17 SPACES

TOTAL PROVIDED = 432 SPACES

COUNTY OF ALBEMARLE, VA

1.95 ACRES

SCOTTSVILLE

MEDICAL OFFICE

28 IMPERIAL DRIVE

MAY 9-11, 2023

NO IMPACT

07800-00-020M4 (500 MARTHA JEFFERSON DR) - PD-MC (HOSPITAL)

07800-00-020C6 (NO ADDRESS) - PD-MC (NO LAND USE ASSIGNED)

07800-00-03100 (NO ADDRESS) - PD-MC (OFFICE)

ACSA FOR WATER & SEWER

UPPER RIVANNA RIVER

STAUNTON, VA. 2440

PD-MC PLANNED DEVELOPMENT MIXED

MEDICAL OFFICE AND DAYCARE

1.26 AC (USED FOR SWM QUALITY CALCULATIONS)

HORIZONTAL: NAD83 VIRGINIA STATE GRID SOUTH ZONE

ZONE X AS PER MAP 51003C0289D DATED 2/4/2005

MIN: BUILDING CODE; MAX: NONE

ENGINEERING INSPECTIONS ARCHITECTURAL REVIEW BOARD DEPARTMENT OF FIRE AND RESCUE ALBEMARLE COUNTY SERVICE AUTHORITY VIRGINIA DEPARTMENT OF TRANSPORTATION HEALTH DEPARTMENT

SIGNATURE PANEL: **APPROVAL** DEPARTMENT OF COMMUNITY DEVELOPMENT PLANNING & ZONING



401 McIntire Road, North Wing Charlottesville, VA 22902-4579 Telephone: 434-296-5832 WWW.ALBEMARLE.ORG

Construction Record Drawings (As-built) and Required **Documents for VSMP**

The following is a list of documents and information required on construction record drawings for stormwater facilities (reference Water Protection Ordinance 17-422). It is preferable that the construction record drawing be prepared by someone other than the designer. Please do not provide design drawings as construction record drawings.

Fee \$353.60 (fee includes the 4% Technology Fee).

Record (as-built) drawing requirements:

- 1) A signed and dated professional seal of the preparing engineer or surveyor.
- 2) The name and address of the firm and individual preparing the drawings on the title sheet.
- 3) Include "as-built drawing" or "record drawing" on the title sheet.
- 4) Show the constructed location of all items associated with each facility, and the inspection records to verify
- proper dimensions, materials and installation. The items include, but are not limited to the following: a) Updated Location with geo-coordinates (northing/easting) of all facilities.
- b) Verified Drainage Area maps for the drainage area treated, and for drainage to the facilities.
- c) Current physical and topographic survey for all earthen structures. Ponds should include a survey of the pond bottom. Surveys should verify pond volumes are per design. Corrections may be required for deviations from the design.
- d) Plants, location and type.
- e) Plans and profiles for all culverts, Pipes, Risers, Weirs and Drainage Structures Display the installed type of drainage structures, culvert/pipe size, weirs, materials, inlets or end treatment(s), inlet and outlet protection, alignment and invert elevations compared to design.
- f) **Ditch Lines** Display the constructed location of all ditch lines and channels, including typical sections
- g) Guardrail, fences or other safety provisions Display the constructed location of all safety provisions; fences, guardrail, including the type, length and applied end treatments, compared to design.
- h) Access roads show location of access roads, surface treatment, drainage, etc, as applicable.
- i) **Easements** Show all platted easements with deed book references labeled. Facilities and drainage must be within platted easements. Provide copies of recorded documents.

Additional Documentation Required with the As-built Submittal:

- 5) Material layers biofilter media, stone layers, sand layers, keyways and cores must be verified as to material types and depths. Provide inspection reports, boring or test pit reports and materials certifications. Biofilter media must be an approved state mix.
- 6) Inspection Records and photographs for pipe trenches and bedding, including underdrains and filter fabric.
- 7) Video Pipe Inspection for any pipes which are not viewable without the need to enter a confined space.
- 8) **Computations** For significant deviations from design, provide sealed computations verifying that the
- as-built condition is equivalent or exceeds design requirements. 9) Compaction reports are required verifying fill compaction in dams.
- 10) Manufacturer(s) certification(s) for proprietary BMP's certifying proper installation and functioning.

Date: 11/30/2022

Albemarle County Engineering Final Plan General Notes Page 1 of 4

ALBEMARLE COUNTY FINAL PLAN GENERAL NOTES

General Construction Notes

- 1. Prior to any construction within any existing public right-of-way, including connection to any existing road, a permit shall be obtained from the Virginia Department of Transportation (VDOT). This plan as drawn may not accurately reflect the requirements of
- the permit. Where any discrepancies occur the requirements of the permit shall govern. 2. All materials and construction methods shall conform to current specifications and standards of VDOT unless otherwise noted.
- Erosion and siltation control measures shall be provided in accordance with the approved erosion control plan and shall be installed prior to any clearing, grading or other
- 4. All slopes and disturbed areas are to be fertilized, seeded and mulched.
- The maximum allowable slope is 2:1 (horizontal:vertical). Where reasonably obtainable, lesser slopes of 3:1 or better are to be achieved.
- 6. Paved, rip-rap or stabilization mat lined ditch may be required when in the opinion of the County Engineer, or designee, it is deemed necessary in order to stabilize a drainage
- 7. All traffic control signs shall conform with the Virginia Manual for Uniform Traffic
- Unless otherwise noted all concrete pipe shall be reinforced concrete pipe Class III. All excavation for underground pipe installation must comply with OSHA Standards for the Construction Industry (29 CFR Part 1926).

GENERAL NOTES

- CONTRACTOR SHALL COORDINATE ALL REQUIREMENTS FOR AS BUILT DOCUMENTATION, AS REQUIRED BY THE LOCALITY. THIS INCLUDES, BUT IS NOT LIMITED TO, TESTING, INSTALLATION DOCUMENTATION, SURVEY, ETC. ALL REQUIREMENTS SHALL BE DISCUSSED WITH THE LOCALITY PRIOR TO THE BEGINNING CONSTRUCTION.
- 2. ALL PAVEMENT AND STORM SEWER MATERIALS AND CONSTRUCTION SHALL BE IN ACCORDANCE WITH CURRENT VIRGINIA DEPARTMENT OF TRANSPORTATION'S SPECIFICATIONS AND STANDARDS.
- ALL MATERIAL AND METHODS FOR WATER AND SANITARY SEWER SYSTEM (PUBLIC AND PRIVATE) INSTALLATION SHALL BE IN ACCORDANCE WITH THE ALBEMARLE COUNTY SERVICE AUTHORITY (ACSA) DESIGN AND CONSTRUCTION STANDARDS.
- PRIOR TO ANY CONSTRUCTION, THE CONTRACTOR SHALL CONSULT THE ENGINEER AND VERIFY THE APPROVAL OF THE PLANS BY ALL
- FEDERAL, STATE AND LOCAL AGENCIES. LAND USE PERMITS (LUP-A) MUST BE OBTAINED FROM THE VIRGINIA DEPARTMENT OF TRANSPORTATION PRIOR TO BEGINNING ANY
- CONSTRUCTION WITHIN THE EXISTING STATE MAINTAINED RIGHT OF WAY (INCLUDING ACCESS). THE CONTRACTOR SHALL VERIFY THE ELEVATIONS OF ALL POINTS OF CONNECTION OR PROPOSED WORK TO EXISTING CURBS, SANITARY
- LINES, WATERLINES, ETC. PRIOR TO CONSTRUCTION. UPON DISCOVERY OF SOILS THAT ARE UNSUITABLE FOR FOUNDATIONS, SUBGRADES, OR OTHER ROADWAY CONSTRUCTION PURPOSES,
- THE CONTRACTOR SHALL IMMEDIATELY CONTACT THE OWNER. THESE AREAS SHALL BE EXCAVATED BELOW PLAN GRADE AS DIRECTED BY THE OWNER'S REPRESENTATIVE, BACKFILLED WITH SUITABLE MATERIAL AND COMPACTED IN ACCORDANCE WITH SPECIFICATIONS.
- ALL STORM SEWER DESIGN AND CONSTRUCTION TO BE IN ACCORDANCE WITH VDOT STANDARDS. ALL STORM SEWER PIPE SHALL BE HDPE IN ACCORDANCE WITH ASTM F2648, UNLESS OTHERWISE NOTED. PIPE SHALL HAVE SMOOTH
- INTERIOR AND ANNULAR EXTERIOR CORRUGATIONS. JOINTS SHALL BE WATERTIGHT ACCORDING TO ASTM D3212.
- SHOP DRAWINGS FOR ALL STORM STRUCTURES SHALL BE SUBMITTED FOR REVIEW.
- ALL CONCRETE SHALL BE A3-AE (AIR ENTRAINED 3,000 PSI), UNLESS OTHERWISE NOTED ALL ENTRANCES ARE TO BE DESIGNED AND CONSTRUCTED IN ACCORDANCE WITH CURRENT VDOT STANDARDS
- DESIGN CHANGES, SPECIFIED MATERIALS CHANGES AND/OR FIELD CHANGES FROM THE APPROVED PLANS NEED TO BE RESUBMITTED TO THE ENGINEER PRIOR TO PROCEEDING WITH THE WORK. A LETTER OF EXPLANATION SHALL ACCOMPANY THE REVISED PLANS AND/OR THE DRAINAGE CALCULATIONS, WHICH MUST BE SUBMITTED AND APPROVED BY THE ENGINEER.
- CONTRACTOR SHALL VERIFY LOCATION AND ELEVATION OF ALL UNDERGROUND UTILITIES SHOWN ON PLANS IN AREAS OF CONSTRUCTION PRIOR TO STARTING WORK. CONTACT ENGINEER IMMEDIATELY IF LOCATION OR ELEVATION IS DIFFERENT FROM THAT SHOWN ON PLAN. IF THERE APPEARS TO BE A CONFLICT, AND/OR UPON DISCOVERY OF ANY UTILITY NOT SHOWN ON THIS PLAN, CALL MISS UTILITY OF CENTRAL VIRGINIA AT 1-800-552-7001. THE OWNER SHALL BE RESPONSIBLE FOR THE RELOCATION OF ANY UTILITY WITHIN EXISTING AND/OR PROPOSED RIGHT-OF-WAY REQUIRED BY THE DEVELOPMENT.
- THE INSTALLATION OF SEWER, WATER, AND GAS MAINS (INCLUDING SERVICE LATERALS AND SLEEVES) SHALL BE COMPLETED PRIOR TO THE PLACEMENT OF AGGREGATE BASE COURSE.
- VDOT & ALBEMARLE COUNTY APPROVAL OF CONSTRUCTION PLANS DOES NOT PRECLUDE THE RIGHT TO REQUIRE ADDITIONAL FACILITIES AS DEEMED NECESSARY
- THE SCHEDULING OF AGGREGATE BASE INSTALLATION AND SUBSEQUENT PAVING ACTIVITIES SHALL ACCOMMODATE FORECAST WEATHER
- CONDITIONS PER SECTION 315 OF THE ROAD AND BRIDGE SPECIFICATIONS 18. THE OWNER'S REPRESENTATIVE SHALL HAVE APPROVED THE AGGREGATE BASE COURSE(S) FOR DEPTH, TEMPLATE AND PERFORMED THE REQUIRED FIELD INSPECTION (PROOF ROLL) PRIOR TO PLACEMENT OF ANY SURFACE COURSE(S). CONTACT THE OWNER FOR INSPECTION FOR THE AGGREGATE BASE COURSE(S) 48 HOURS PRIOR TO APPLICATION OF THE SURFACE COURSE(S).
- 19. ALL VEGETATION AND ORGANIC MATERIAL IS TO BE REMOVED FROM THE PROPOSED PAVEMENT LIMITS PRIOR TO CONDITIONING OF THE
- CERTIFICATION AND SOURCE OF MATERIALS ARE TO BE SUBMITTED TO THE OWNER'S REPRESENTATIVE FOR ALL MATERIALS AND BE IN ACCORDANCE WITH THE ROAD AND BRIDGE SPECIFICATIONS, AND ROAD AND BRIDGE STANDARDS
- APPROVAL OF A DETAILED CONSTRUCTION SEQUENCING/MAINTENANCE OF TRAFFIC NARRATIVE FOR THE WORK ZONE IS A PREREQUISITE FOR ISSUANCE OF A LAND USE PERMIT ALLOWING ACCESS TO AND CONSTRUCTION WITHIN VDOT MAINTAINED RIGHT OF WAY. CONTRACTOR SHALL PROVIDE A SEQUENCE OF CONSTRUCTION/MAINTENANCE OF TRAFFIC PLAN IN ACCORDANCE WITH THE STANDARDS AND GUIDELINES CONTAINED IN THE 2011 EDITION OF THE VIRGINIA WORK AREA PROTECTION MANUAL FOR REVIEW BY THE ENGINEER. OWNER'S REPRESENTATIVE, AND VDOT PRIOR TO STARTING WORK THAT IMPACTS TRAFFIC ON STATE ROADS.
- 22. GRADE LINES ON PROFILES DENOTE FINISHED GRADE.
- ALL APPROACH GUTTERS TO SAG INLETS SHALL MAINTAIN A MINIMUM SLOPE OF 0.004 ft./ft.
- ALL NEW HANDICAP ACCESSIBLE REQUIREMENTS ON-SITE (PARKING SPACES, ACCESS AISLES, AND ACCESSIBLE ROUTES) AND WITHIN ALL
- NEW STRUCTURES SHALL COMPLY WITH THE LATEST VERSION OF ALL LOCAL, STATE, AND FEDERAL REGULATIONS.
- TREE PROTECTION AREAS TO BE FREE OF STORED MATERIALS AND PARKED EQUIPMENT HORIZONTAL AND VERTICAL SIGHT DISTANCES SHALL BE FREE OF PARKED VEHICLES.
- VISIBILITY OF ALL MECHANICAL EQUIPMENT FROM ENTRANCE CORRIDOR ROADWAYS SHALL BE ELIMINATED.
- ELECTRICAL, COMMUNICATION, AND GAS SITE WORK IS NOT DETAILED ON THE CIVIL PLANS. CONTRACTOR SHALL COORDINATE WITH
- UTILITY PROVIDER, MEP ENGINEER, AND OWNER FOR ALL WORK RELATING TO THESE SYSTEMS. ALL ROOF DRAINS SHALL BE CONNECTED TO THE STORM SEWER SYSTEM AS SHOWN ON THE PLANS.
- 30. LIGHTING NOTE: EACH OUTDOOR LUMINAIRE EQUIPPED WITH A LAMP THAT EMITS 3,000 OR MORE INITIAL LUMENS SHALL BE A FULL CUTOFF LUMINAIRE AND SHALL BE ARRANGED OR SHIELDED TO REFLECT LIGHT AWAY FROM ADJOINING RESIDENTIAL DISTRICTS AND AWAY FROM ADJACENT ROADS. THE SPILLOVER OF LIGHTING FROM LUMINAIRES ONTO PUBLIC ROADS AND PROPERTY IN RESIDENTIAL OR RURAL AREAS ZONING DISTRICTS SHALL NOT EXCEED ONE HALF FOOTCANDLE.
- 31. SEE "EROSION AND SEDIMENT CONTROL PLAN NOTES & DETAILS," C3.0, FOR RELATED GENERAL NOTES.

FIRE PREVENTION NOTES

- SMOKING SHALL BE PROHIBITED IN AREAS WHERE SMOKING CONDITIONS MAKE SMOKING A HAZARD AND THESE AREAS SHALL BE
- DESIGNATED WITH NO SMOKING SIGNS PER VIRGINIA STATEWIDE FIRE PREVENTION CODE. AREAS WHERE SMOKING CAN OCCUR, SHALL HAVE APPROPRIATE RECEPTACLES FOR DISCARDED SMOKING MATERIALS PER VIRGINIA
- STATEWIDE FIRE PREVENTION CODE. PER THE VIRGINIA STATEWIDE FIRE PREVENTION CODE, VEHICULAR ACCESS FOR FIREFIGHTING SHALL BE PROVIDED AT ALL CONSTRUCTION AND DEMOLITION SITES, PROVIDE ACCESS TO WITHIN 100 FT. OF TEMPORARY OR PERMANENT FIRE DEPARTMENT
- CONNECTIONS, AND HAVE NO OVERHEAD WIRING OR OTHER OVERHEAD OBSTRUCTIONS LOWER THAN 13 FT. 6 INCHES; THIS ACCESS MAY BE VIA PERMANENT OR TEMPORARY ROAD, BUT SHALL BE CAPABLE OF SUPPORTING FIRE APPARATUS IN ALL WEATHER CONDITIONS. CONTRACTOR SHALL ENSURE THE STREET NUMBERS ARE ALWAYS PLAINLY VISIBLE FROM THE FRONTAGE STREET DURING CONSTRUCTION
- PER THE VIRGINIA STATEWIDE FIRE CODE. AN APPROVED WATER SUPPLY FOR FIREFIGHTING OPERATIONS SHALL BE IN PLACE AND AVAILABLE AS SOON AS COMBUSTIBLE MATERIALS
- WASTE AND COMBUSTIBLE DEBRIS SHALL BE REMOVED FROM THE BUILDING AT THE END OF EACH DAY AND DISPOSED OF IN ACCORDANCE WITH THE VIRGINIA STATEWIDE FIRE CODE.
- FIRE EXTINGUISHERS SHALL BE PROVIDED, WITH NOT LESS THAN ONE APPROVED FIRE EXTINGUISHER AT EACH STAIRWELL, ON ALL FLOOR LEVELS WHERE COMBUSTIBLE MATERIALS HAVE ACCUMULATED, IN EVERY STORAGE AND CONSTRUCTION SHED AND IN AREAS OF SPECIAL; HAZARDS, SUCH AS WHERE FLAMMABLE AND COMBUSTIBLE LIQUIDS ARE STORED OR USED, IN ACCORDANCE WITH THE VIRGINIA
- OPERATIONS INVOLVING THE USE OF CUTTING AND WELDING SHALL COMPLY WITH THE VIRGINIA STATEWIDE FIRE PREVENTION CODE AND SHALL REQUIRE A PERMIT FROM THE ALBEMARLE COUNTY FIRE MARSHAL'S OFFICE.
- THE THREADS FOR THE FIRE DEPARTMENT USE MUST BE C & O THREADS

BLASTING NOTES

BLASTING SHALL NOT BE PERMITTED ON THIS PROJECT.

ACSA GENERAL WATER & SEWER CONDITIONS (REV 09/17/2021)


- 1. WORK SHALL BE SUBJECT TO INSPECTION BY ALBEMARLE COUNTY SERVICE AUTHORITY (ACSA) INSPECTORS. THE CONTRACTOR WILL
- BE RESPONSIBLE FOR NOTIFYING THE PROPER ACSA OFFICIALS AT THE START OF THE WORK.
- 2. THE ALBEMARLE COUNTY SERVICE AUTHORITY SHALL HAVE ACCESS TO USE THE AIRSPACE ABOVE THE LOCATIONS OF
- CONSTRUCTION FOR THE FLIGHT OF UNMANNED AERIAL VEHICLES FOR THE PURPOSE OF IMAGERY COLLECTION. 3. THE LOCATION OF EXISTING UTILITIES ACROSS THE LINE OF THE PROPOSED WORK ARE NOT NECESSARILY SHOWN ON THE PLANS AND WHERE SHOWN ARE ONLY APPROXIMATELY CORRECT. THE CONTRACTOR SHALL, ON HIS OWN INITIATIVE, LOCATE ALL UNDERGROUND
- LINES AND STRUCTURES, AS NECESSARY 4. ALL MATERIALS AND CONSTRUCTION SHALL COMPLY WITH THE CURRENT EDITION OF THE GENERAL WATER AND SEWER
- CONSTRUCTION SPECIFICATIONS. AS ADOPTED BY THE ACSA.
- DATUM FOR ALL ELEVATIONS SHOWN IN NATIONAL GEODETIC SURVEY. THE CONTRACTOR SHALL BE RESPONSIBLE FOR NOTIFYING MISS UTILITY (1-800-552-7001).
- 7. ALL WATER AND SEWER PIPES SHALL HAVE A MINIMUM OF THREE AND A HALF (3.5) FEET OF COVER MEASURED FROM THE TOP OF PIPE,
- OVER THE CENTERLINE OF PIPE. THIS INCLUDES ALL FIRE HYDRANT LINES, SERVICE LATERALS AND WATER LINES, ETC. 8. ALL WATER AND SEWER APPURTENANCES ARE TO BE LOCATED OUTSIDE OF ROADSIDE DITCHES.
- 9. VALVES ON DEAD END LINES SHALL BE RODDED TO PROVIDE ADEQUATE RESTRAINT FOR THE VALVE DURING A FUTURE EXTENSION OF
- 10. TREES ARE NOT PERMITTED IN THE ACSA EASEMENT.
- 11. THE CONTRACTOR SHALL BE RESPONSIBLE TO COMPLY WITH THE NO-LEAD REGULATION REGARDING BRASS FITTINGS EFFECTIVE JANUARY 4, 2014 (SENATE BILL 3874 WHICH AMENDS THE SAFE DRINKING WATER ACT).
- 12. THE SEWER LATERAL BEYOND THE CONNECTION AT THE SEWER MAIN SHALL BE PRIVATE. THE SEWER LATERAL STUB-OUT SHALL UNDERGO THE ACSA LOW-PRESSURE AIR TEST TO SATISFY COUNTY TESTING REQUIREMENTS. VISUAL INSPECTION OF THE SEWER
- UNDER AN "OTHER PLUMBING" PERMIT WHICH MUST BE OBTAINED BY THE CONTRACTOR. 13. THE SEWER LATERAL BEYOND THE CONNECTION AT A MANHOLE SHALL BE PRIVATE, VISUAL INSPECTION AND PRESSURE TESTING OF THE SEWER LATERAL SHALL BE WITNESSED BY THE COUNTY BUILDING INSPECTIONS DEPARTMENT. THIS INSPECTION SHALL OCCUR

LATERAL STUB-OUT SHALL BE WITNESSED BY THE COUNTY BUILDING INSPECTIONS DEPARTMENT. THIS INSPECTION SHALL OCCUR

- UNDER AN "OTHER PLUMBING" PERMIT WHICH MUST BE OBTAINED BY THE CONTRACTOR. 14. THE FIRE SPRINKLER MAIN DOWNSTREAM OF THE GATE VALVE IS PRIVATE. VISUAL INSPECTION AND TESTING OF THE FIRE SPRINKLER
- MAIN DOWNSTREAM OF THE GATE VALVE SHALL BE WITNESSED BY THE COUNTY BUILDING INSPECTIONS DEPARTMENT. THIS INSPECTION SHALL OCCUR UNDER AN "OTHER PLUMBING" PERMIT WHICH MUST BE OBTAINED BY THE CONTRACTOR.
- 15. ALL FLUSHING OF FIRE SPRINKLER MAINS SHALL NOT OCCUR UNTIL APPROVAL IS GIVEN BY THE ACSA. 16. PRIOR TO BACKFLOW PREVENTION DEVICE TESTING AND THE ESTABLISHMENT OF WATER SERVICE, ALL BACKFLOW PREVENTIN DEVICE INSTALLATIONS SHALL MEET THE ACSA BACKFLOW REQUIREMENTS AS DETAILED IN SECTION 8 OF THE MOST RECENT REVISION OF THE ACSA RULES AND REGULATIONS.
- 17. A DEED OF EASEMENT PLAT FOR THE UTILITY EASEMENTS, APPROVED BY THE ACSA, SHALL BE RECORDED PRIOR TO ANY WATER AND/OR SEWER SERVICE BEING ESTABLISHED.

NOTE: IT IS THE CONTRACTOR'S RESPONSIBILITY TO REFERENCE CURRENT DETAILS IN THE VDOT ROAD & BRIDGE STANDARDS.

| | VDOT DETAILS LEGEND | | | | | | |
|---------------------|--|---------|--|--|--|--|--|
| STANDARD | TITLE | PAGE | | | | | |
| DI-2, 3A, 3B, 3C | STANDARD CURB DROP INLET (12" TO 24" PIPE: MAXIMUM DEPTH (H) = 9') | | | | | | |
| | DIMENSIONS, NOTES, AND QUANTITIES | 104.04 | | | | | |
| | STANDARD CURB DROP INLET (12" TO 30" PIPE: MAXIMUM DEPTH (H) = 8') | 104.09 | | | | | |
| | DIMENSIONS, NOTES, AND QUANTITIES | 104.10 | | | | | |
| MH-1 | MANHOLE FOR 12" TO 48" PIPE CULVERT | 106.01 | | | | | |
| | STANDARD MANHOLE FRAME AND COVER | 106.02 | | | | | |
| | STANDARD MANHOLE FRAME AND COVER | 106.04 | | | | | |
| MH-2 | PRECAST MANHOLE | 106.07 | | | | | |
| IS-1 | STANDARD METHOD OF SHAPING MANHOLE & INLET INVERTS | 106.08 | | | | | |
| PB-1 | INSTALL. OF PIPE CULVERTS AND STORM SEWERS CIR. PIPE BEDDING AND BACKFILL - METHOD "A" | 107.01 | | | | | |
| CG-2 | STANDARD 6" CURB | 201.01 | | | | | |
| CG-6 | COMBINATION 6" CURB AND GUTTER | 201.03 | | | | | |
| CG-11 | STANDARD ENTRANCE GUTTER | 203.04 | | | | | |
| CG-12 | CG-12 DETECTABLE WARNING SURFACE (GENERAL NOTES) | 204.01 | | | | | |
| | CG-12 DETECTABLE WARNING SURFACE (TYPE A, PERPENDICULAR APPLICATION) | 204.02 | | | | | |
| | CG-12 DETECTABLE WARNING SURFACE (TYPE B, PARALLEL APPLICATION) | 204.03 | | | | | |
| | CG-12 DETECTABLE WARNING SURFACE (TYPE C, PARALLEL & PERPENDICULAR APPLICATION) | 204.04 | | | | | |
| | CG-12 DETECTABLE WARNING SURFACE (MEDIAN AND REFUGE ISLAND APPLICATIONS) TYPE M1, M2, & R11, R12 | 204.05 | | | | | |
| WP-2 | PAVEMENT WIDENING | 303.02 | | | | | |
| PM-10 | PAVEMENT WORD, SYMBOL, AND ARROW MARKINGS | 501.20 | | | | | |
| STP-1 | SQUARE TUBE SIGN POST | 1321.12 | | | | | |
| | SQUARE TUBE SIGN POST - FOUNDATION TYPE D AND E DETAILS | 1321.17 | | | | | |

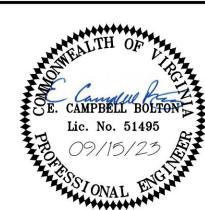

HIS DRAWING PREPARE
CHARLOTTESVILLE C
Avenue, Suite 200 | Cha


09/15/2023 DRAWN BY VAN NIEKERI **DESIGNED BY**


VAN NIEKERI CHECKED BY C. BOLTON


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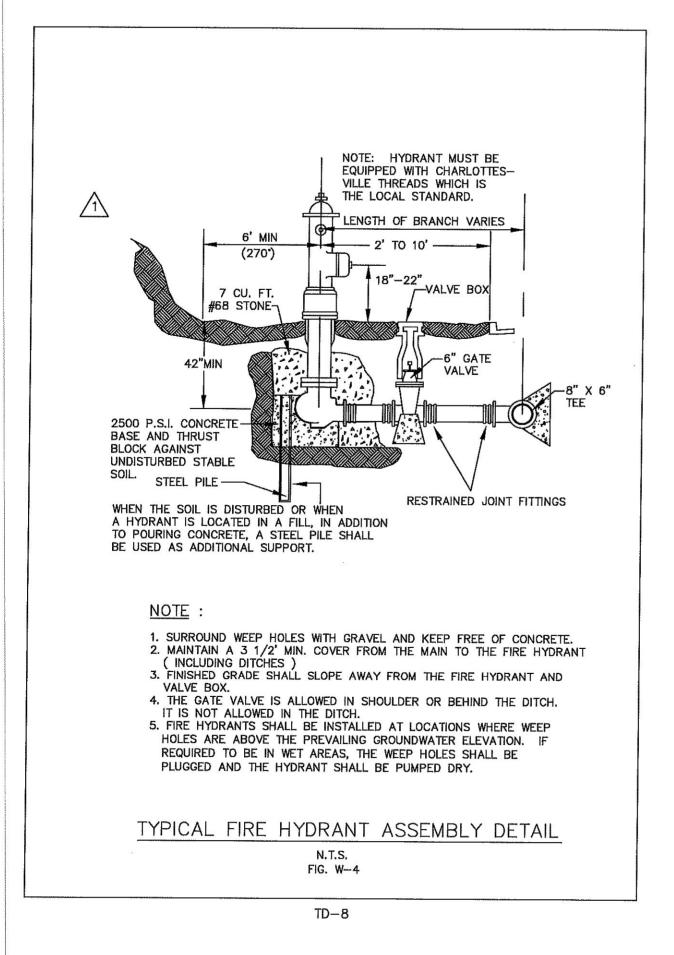
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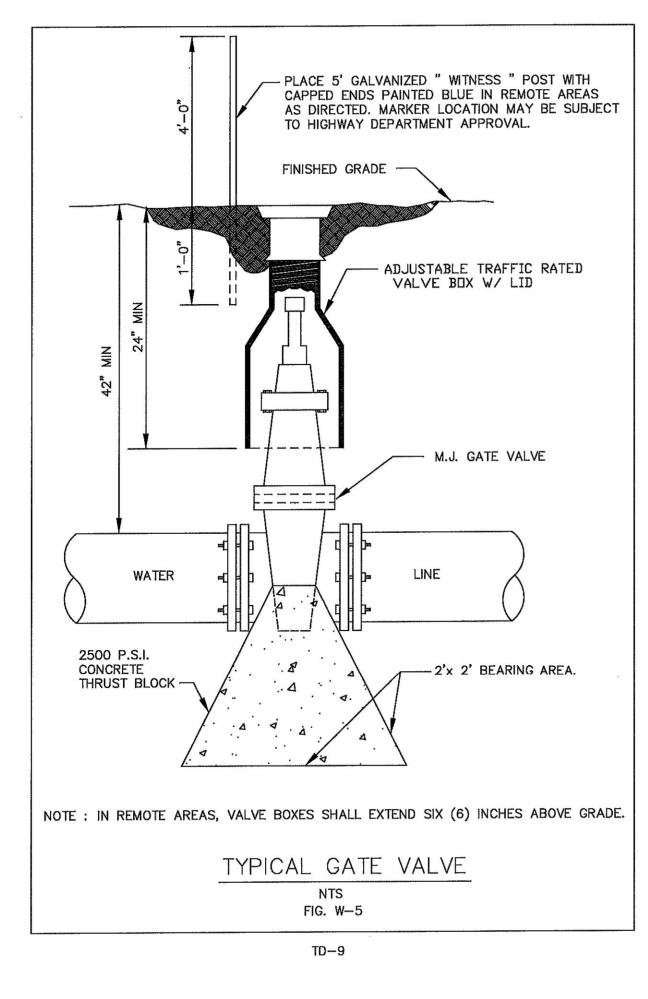
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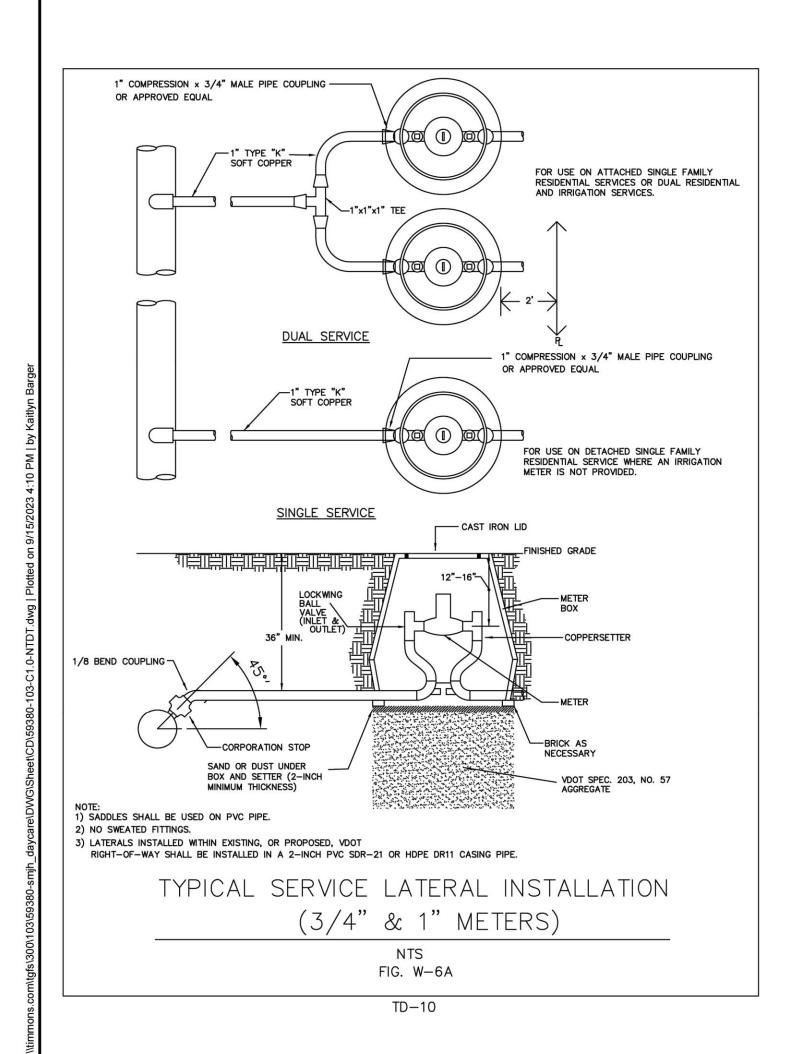








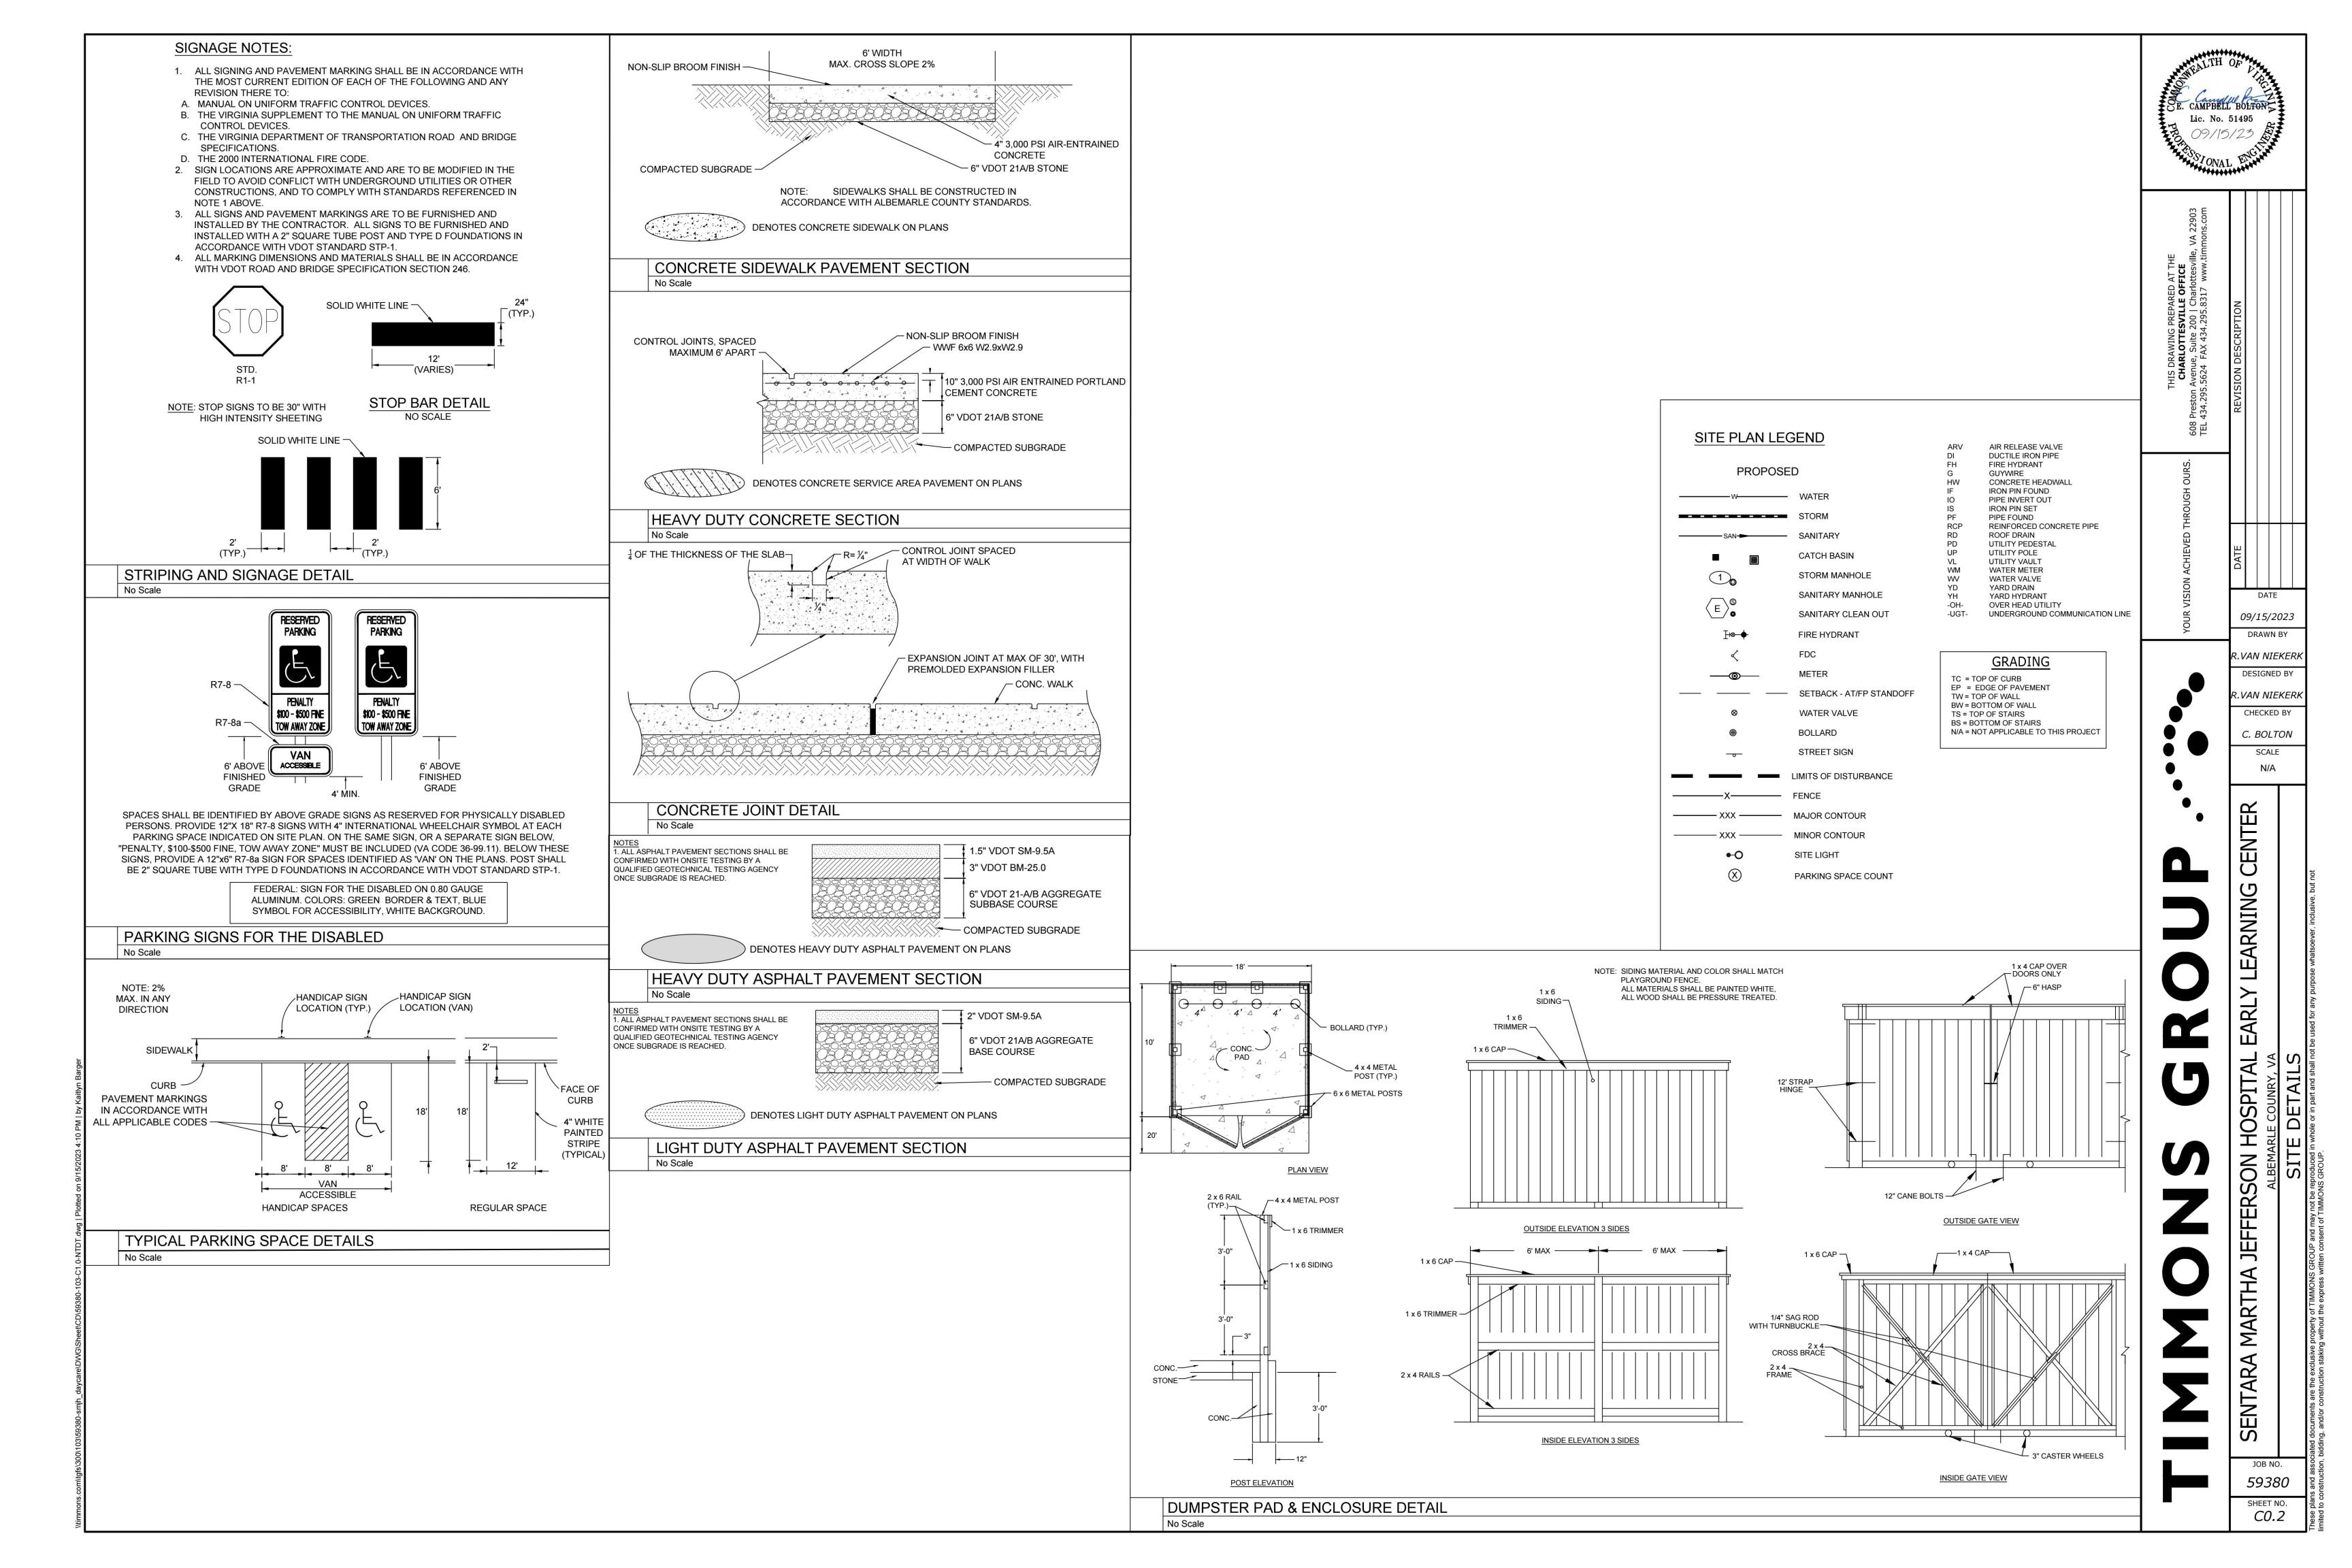


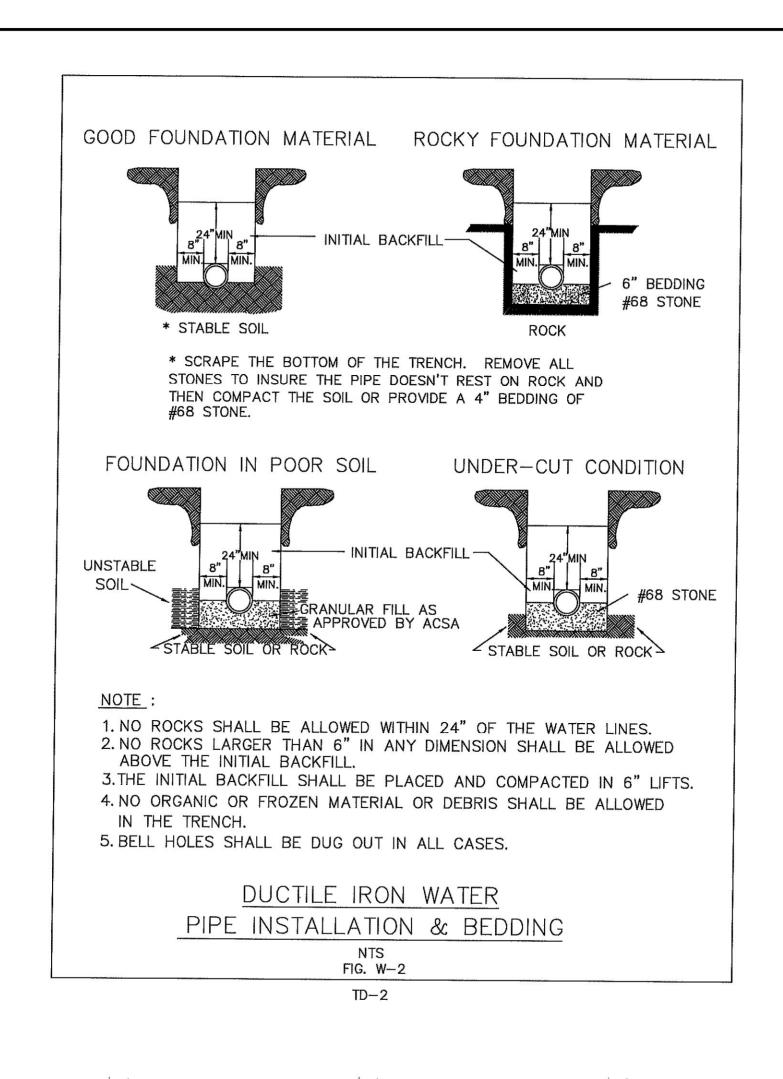


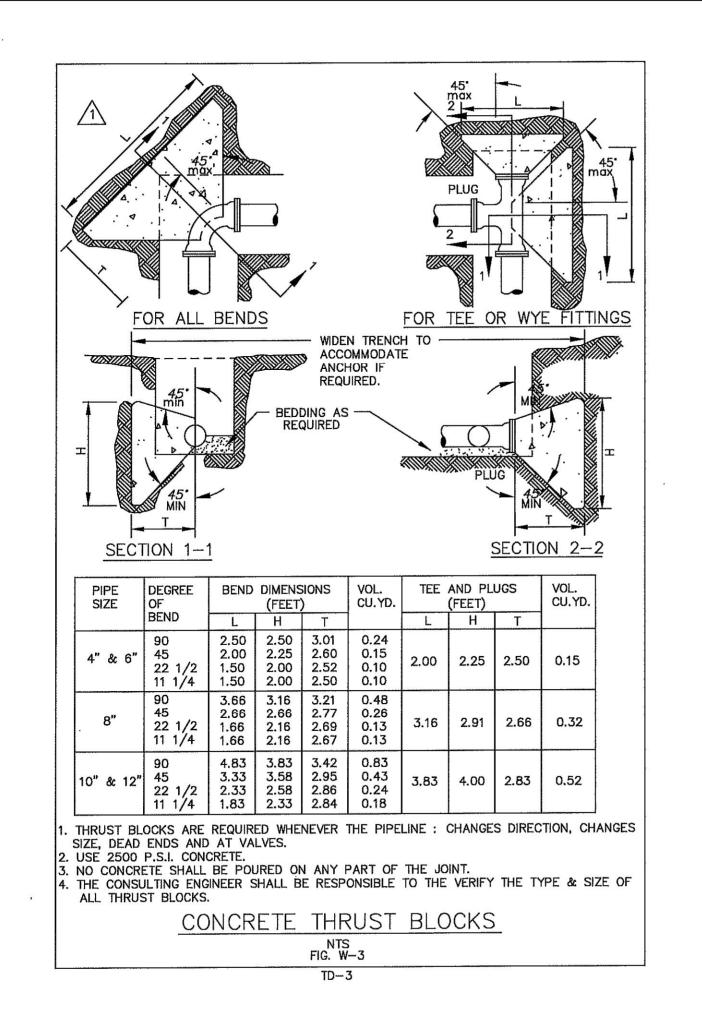

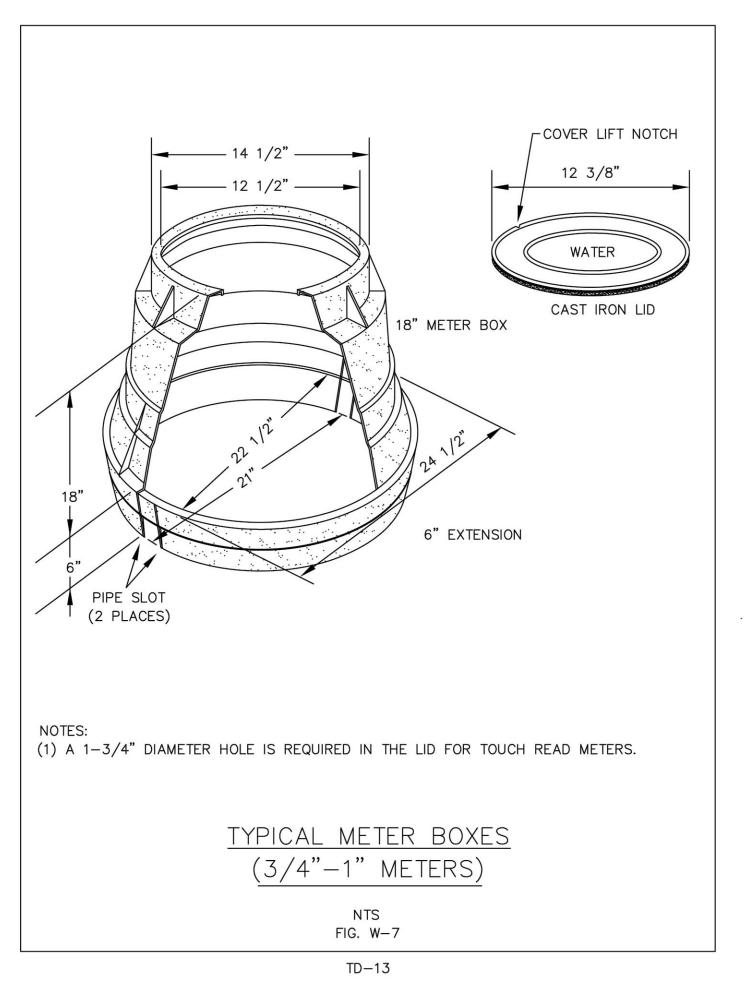

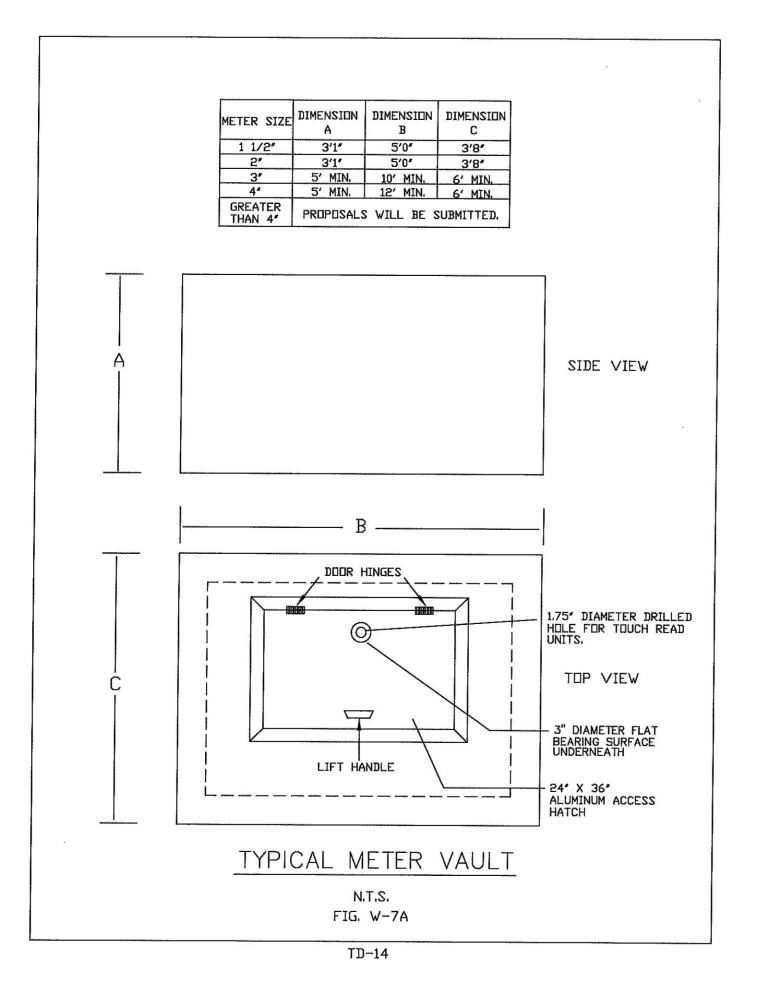

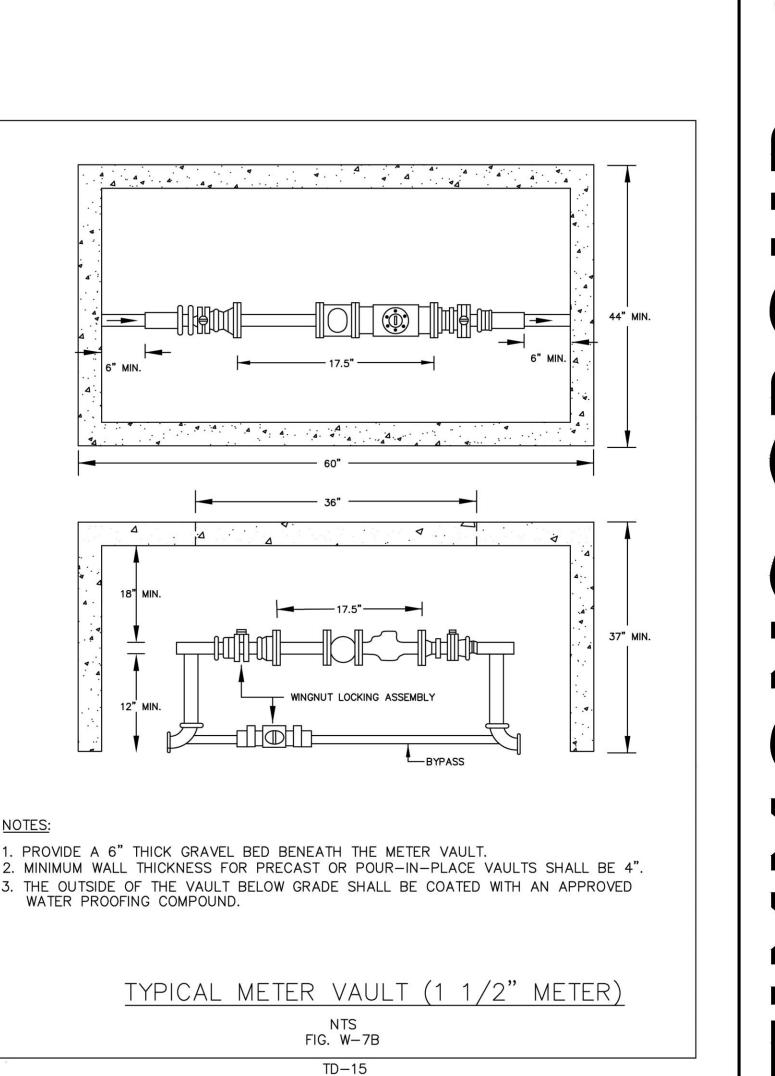

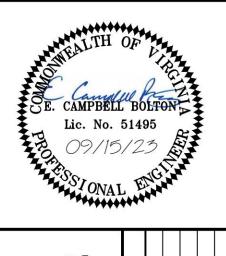

DRAWN BY VAN NIEKERK **DESIGNED BY** VAN NIEKERK CHECKED BY C. BOLTON SCALE


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59380 SHEET NO. C0.3





3. ALL JOINTS, LIFT HOLES, INLETS, OUTLETS TO BE SEALED & GROUTED INSIDE AND OUT.

> TYPICAL MANHOLE SECTION SHOWING BRANCH TIE-IN

> > N.T.S FIG. S-I-A
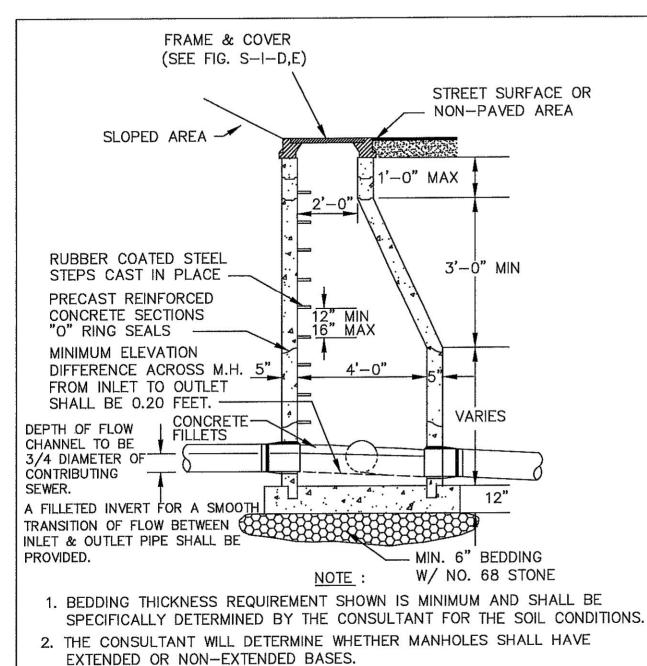
> > > TD-25

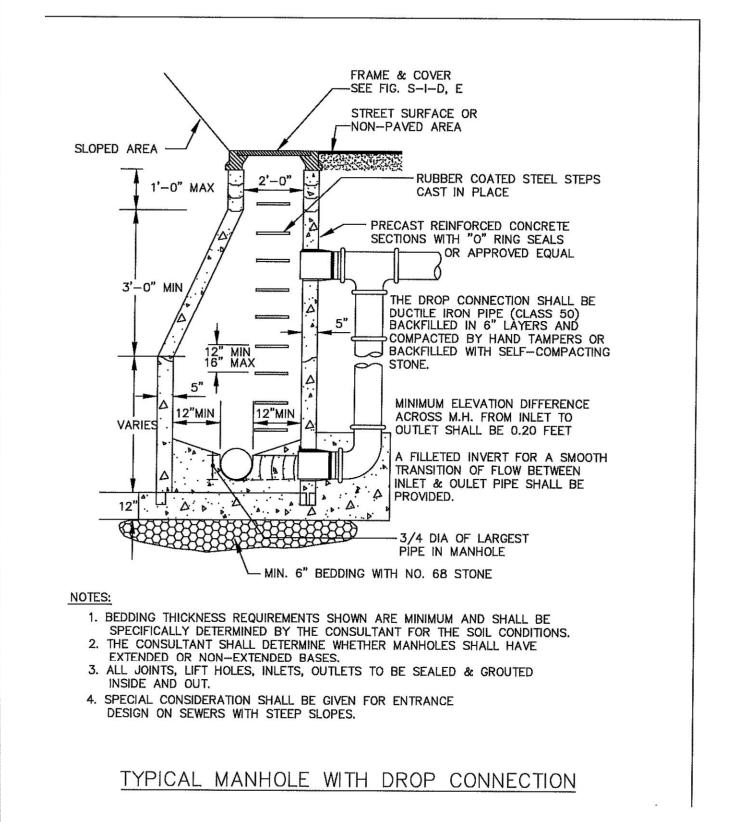

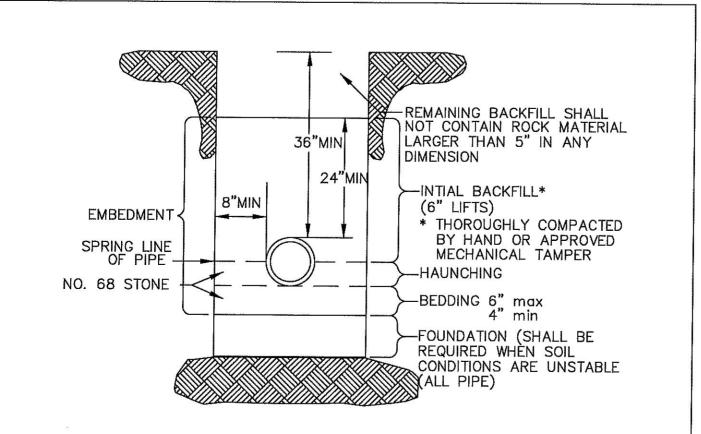



- 1. OPEN CUTS IN PAVED AREAS WITHIN EXISTING VDOT RIGHT-OF-WAY SHALL BE BACKFILLED ENTIRELY WITH NO. 21A STONE.
- 2. FOR DUCTILE IRON PIPE THE BOTTOM OF THE TRENCH SHALL BE SCRAPED AND COMPACTED, AND ALL STONES REMOVED OR A 4" BEDDING OF NO. 68 STONE SHALL BE PROVIDED
- 3. WHERE ROCK IS ENCOUNTERED PIPE SHALL BE INSTALLED ON A MINIMUM 6" BEDDING OF NO. 68 STONE


TYPICAL SEWER PIPE INSTALLATION IN TRENCH


> NTS FIG. S-3

> > TD-34

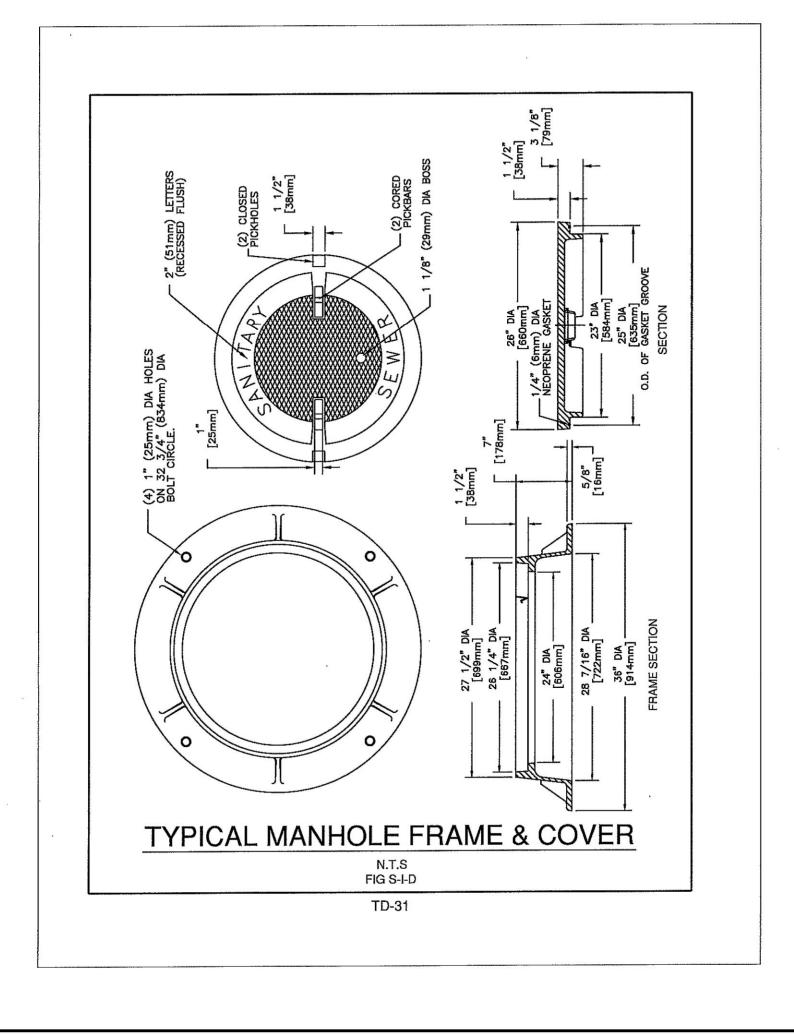

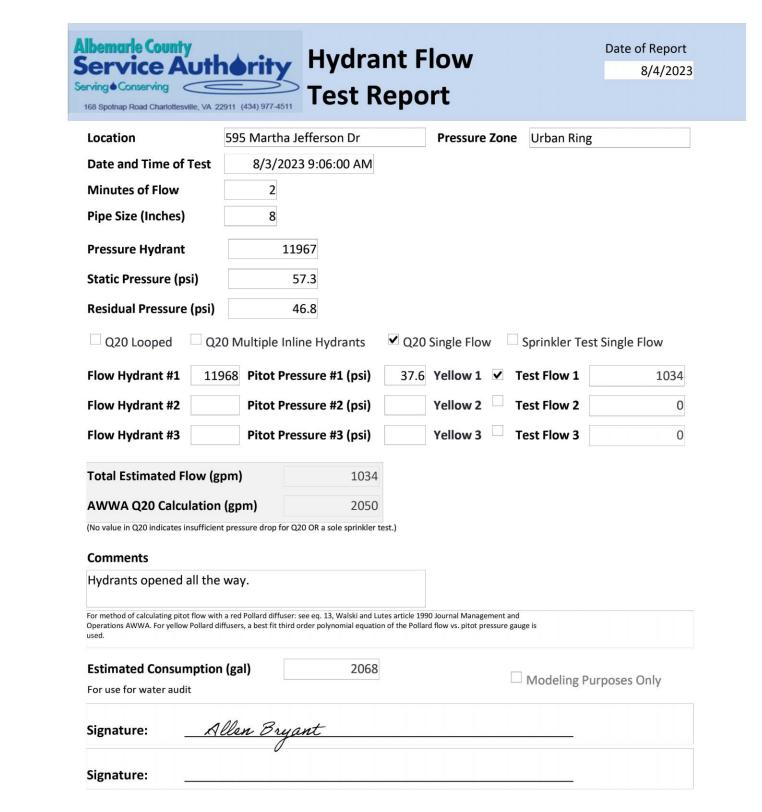

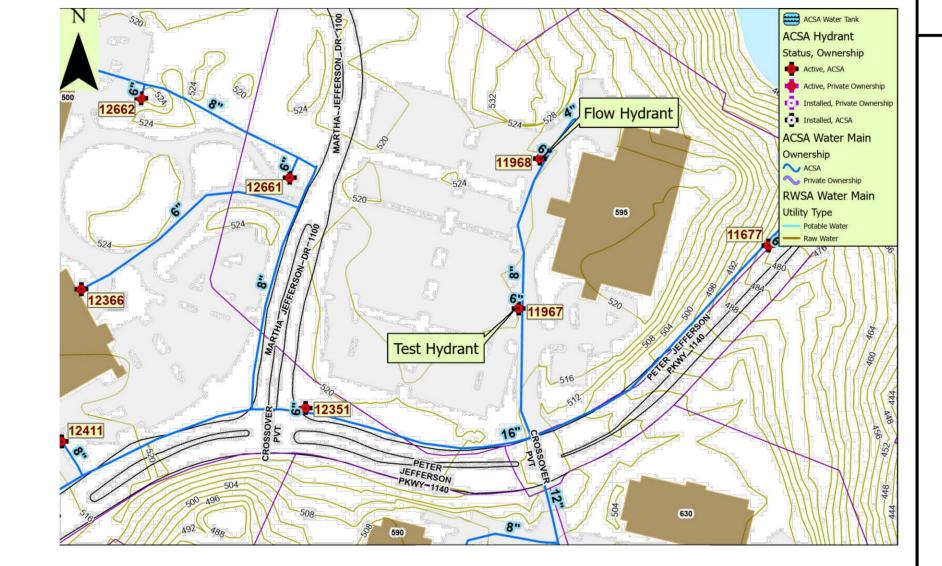

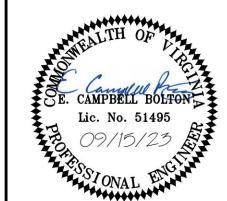

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DATE

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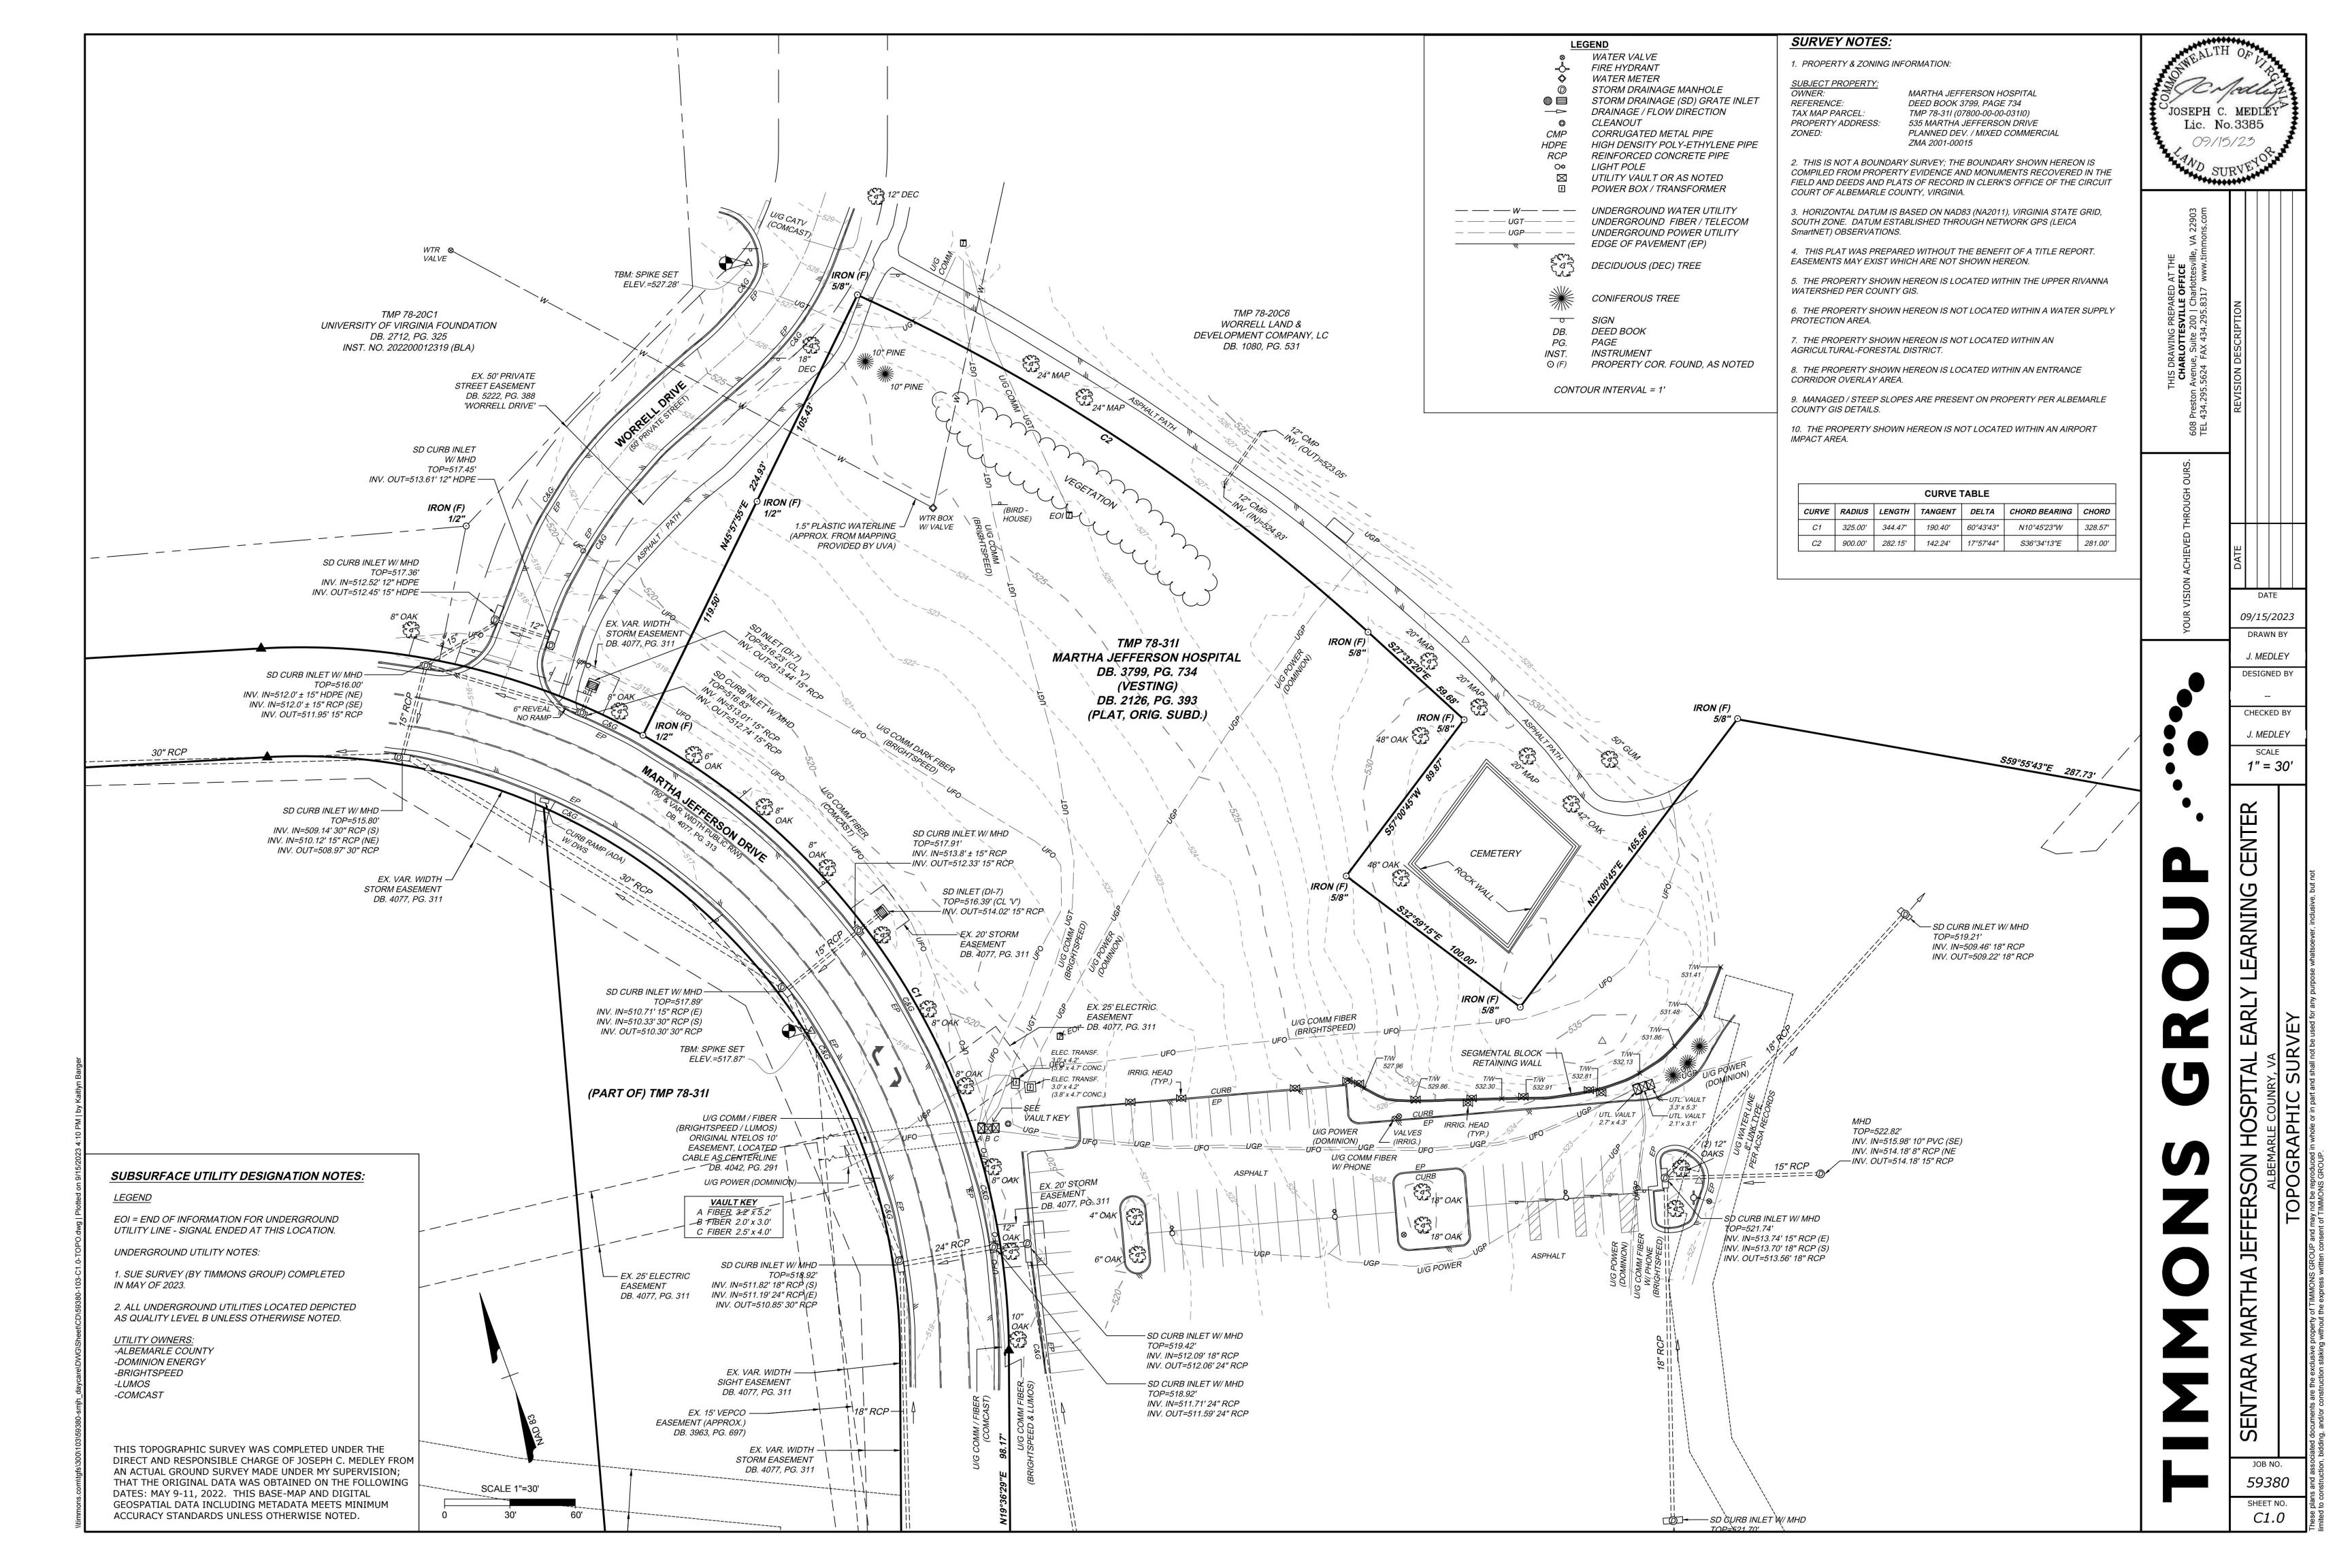
.VAN NIEKERK CHECKED BY C. BOLTON SCALE

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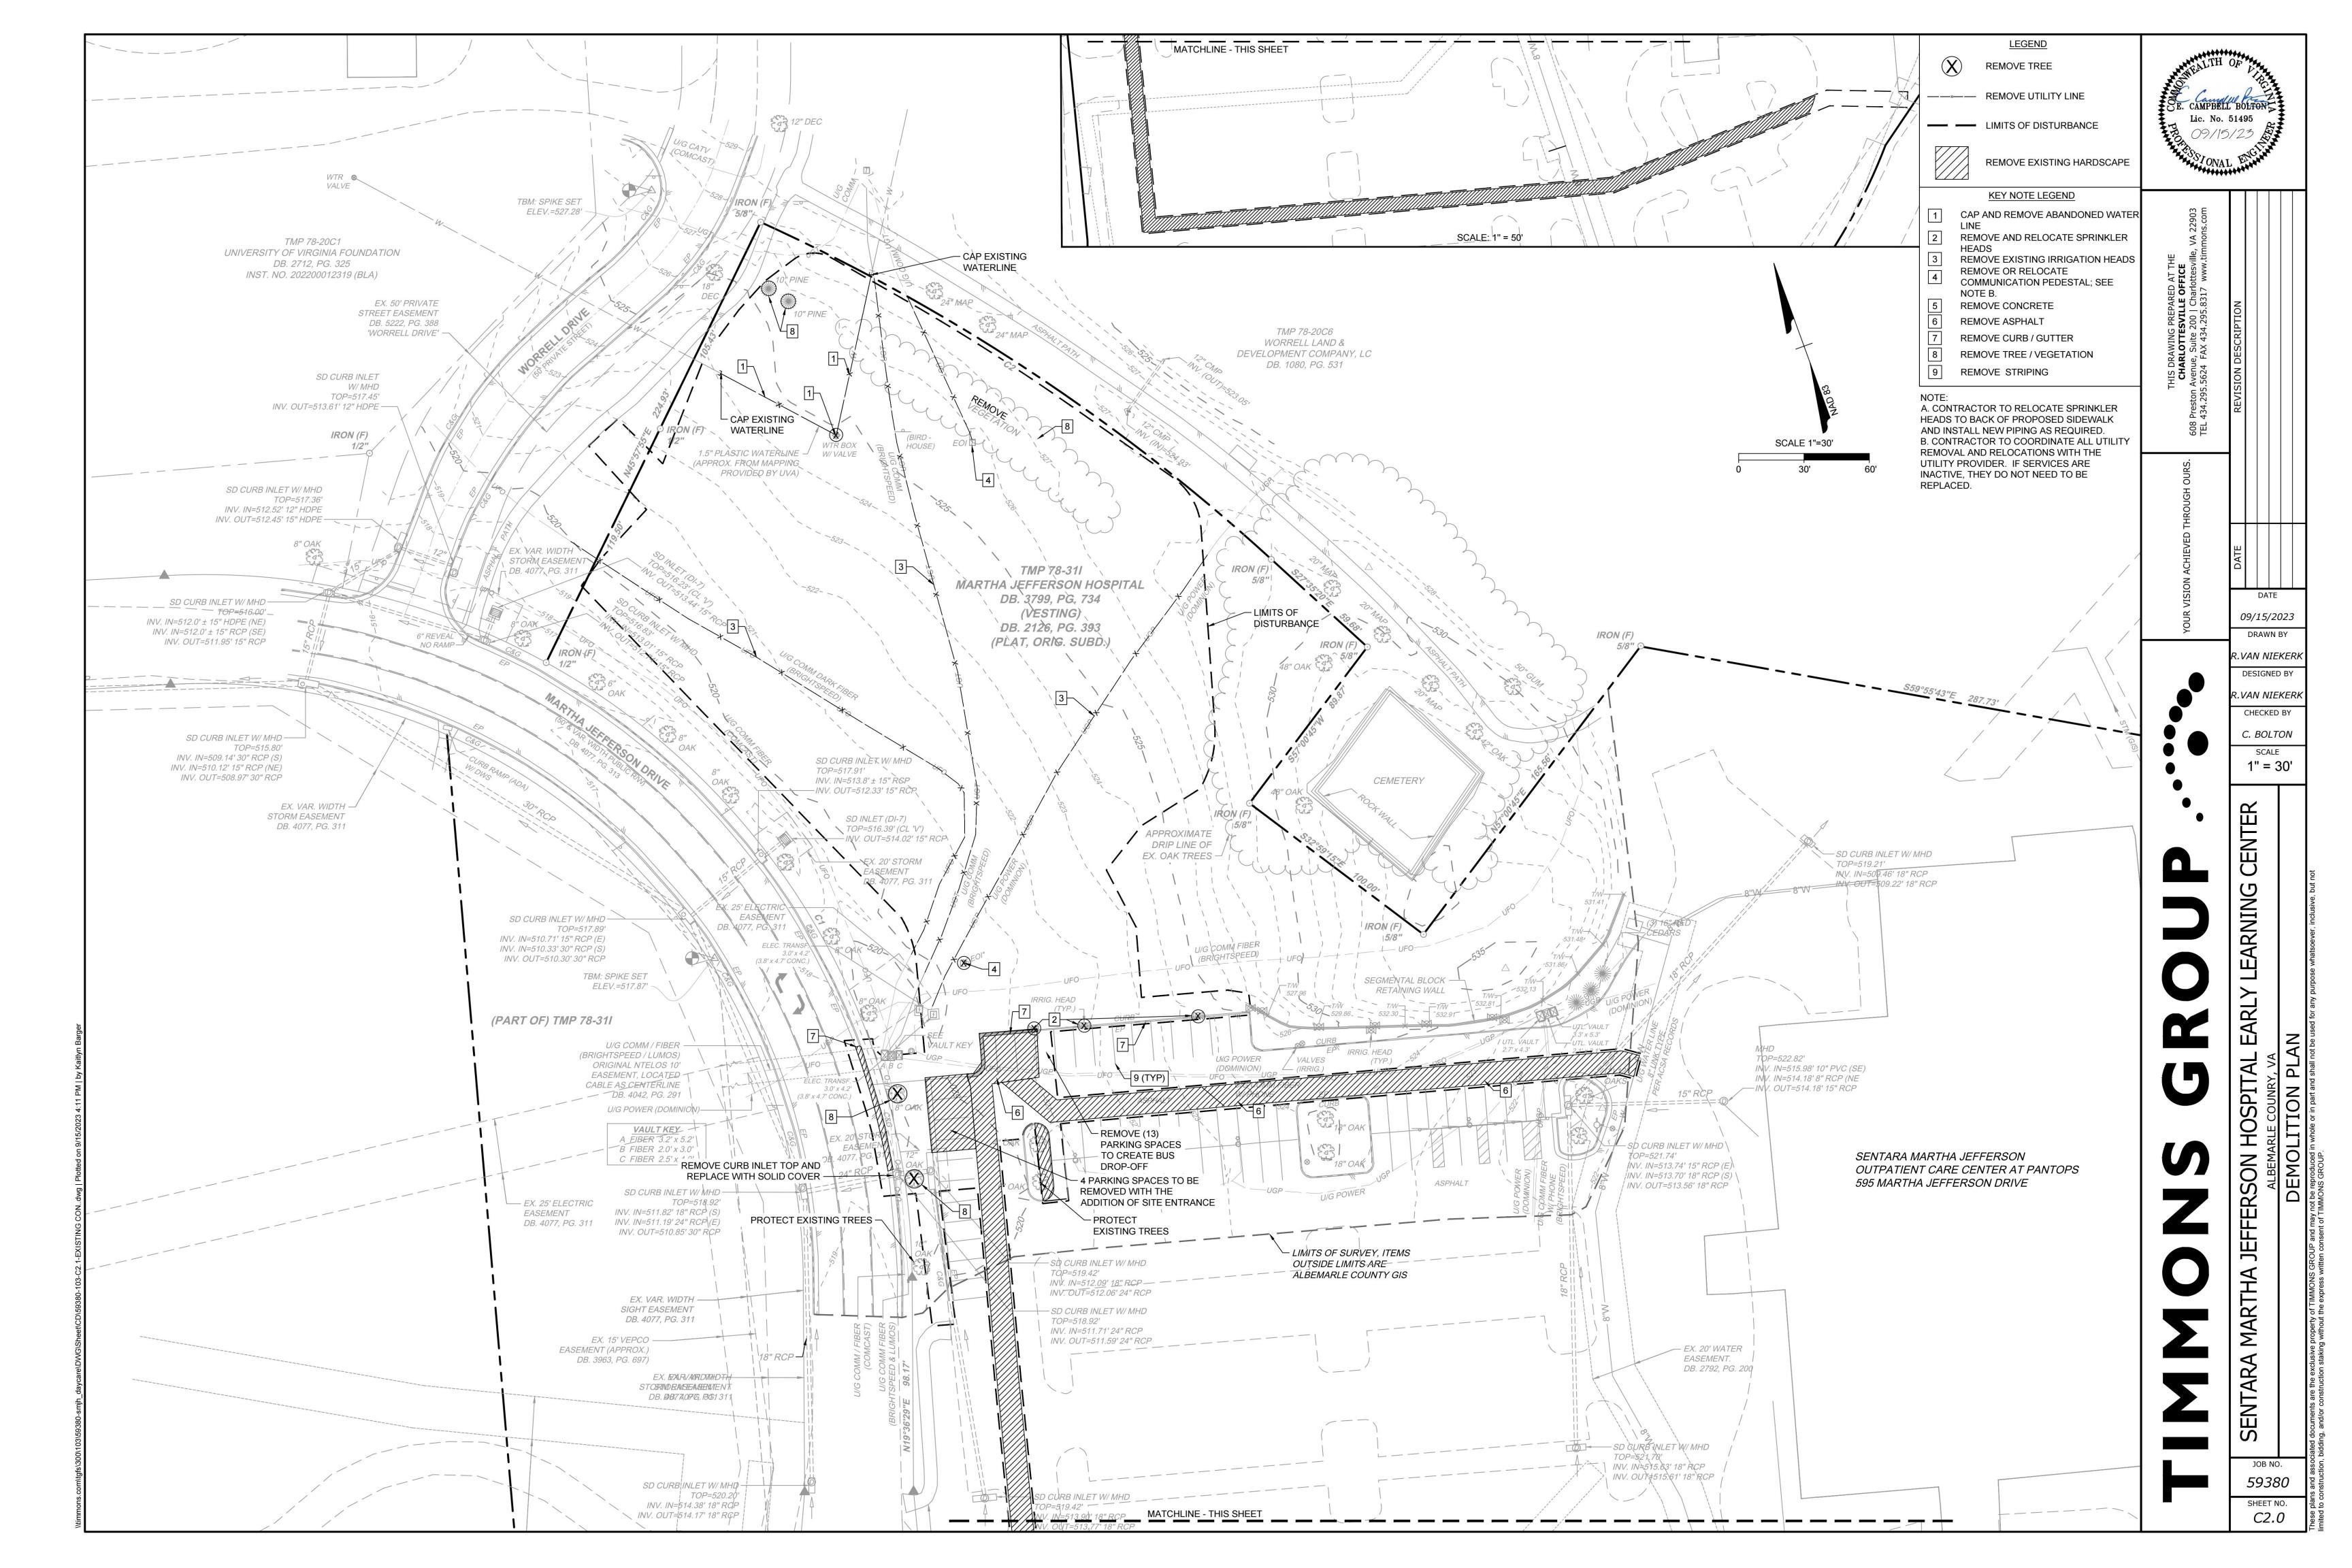
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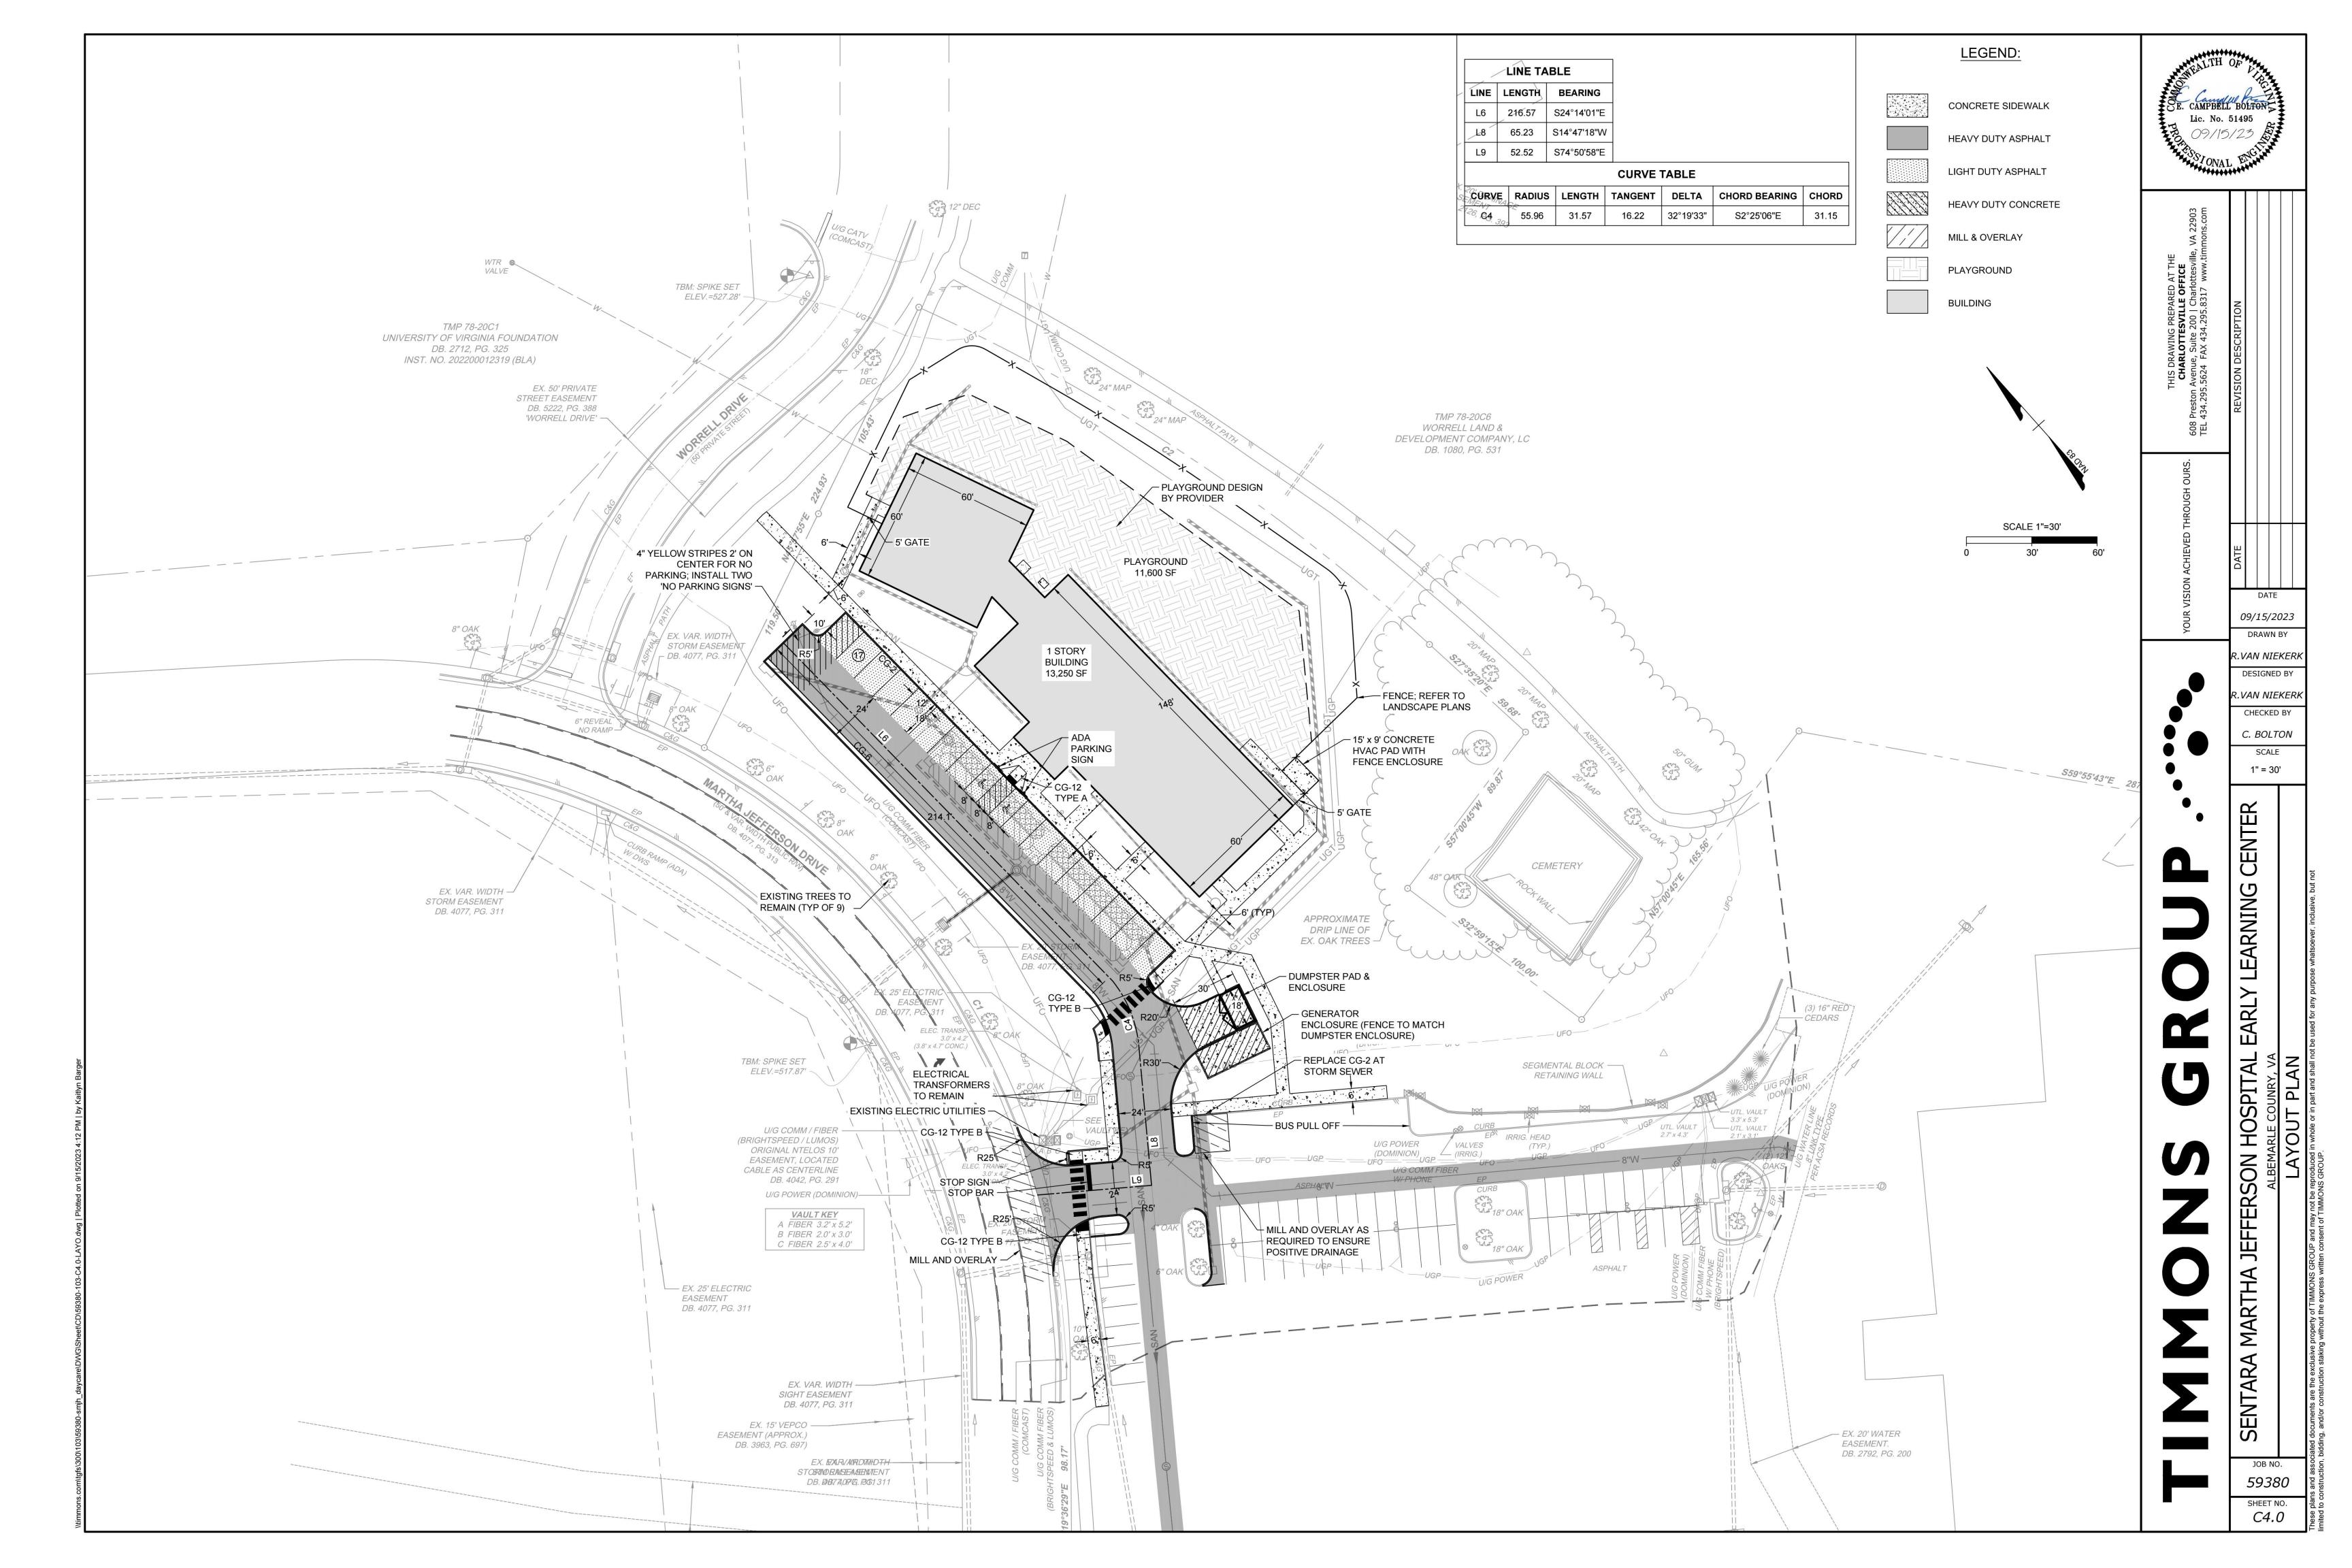
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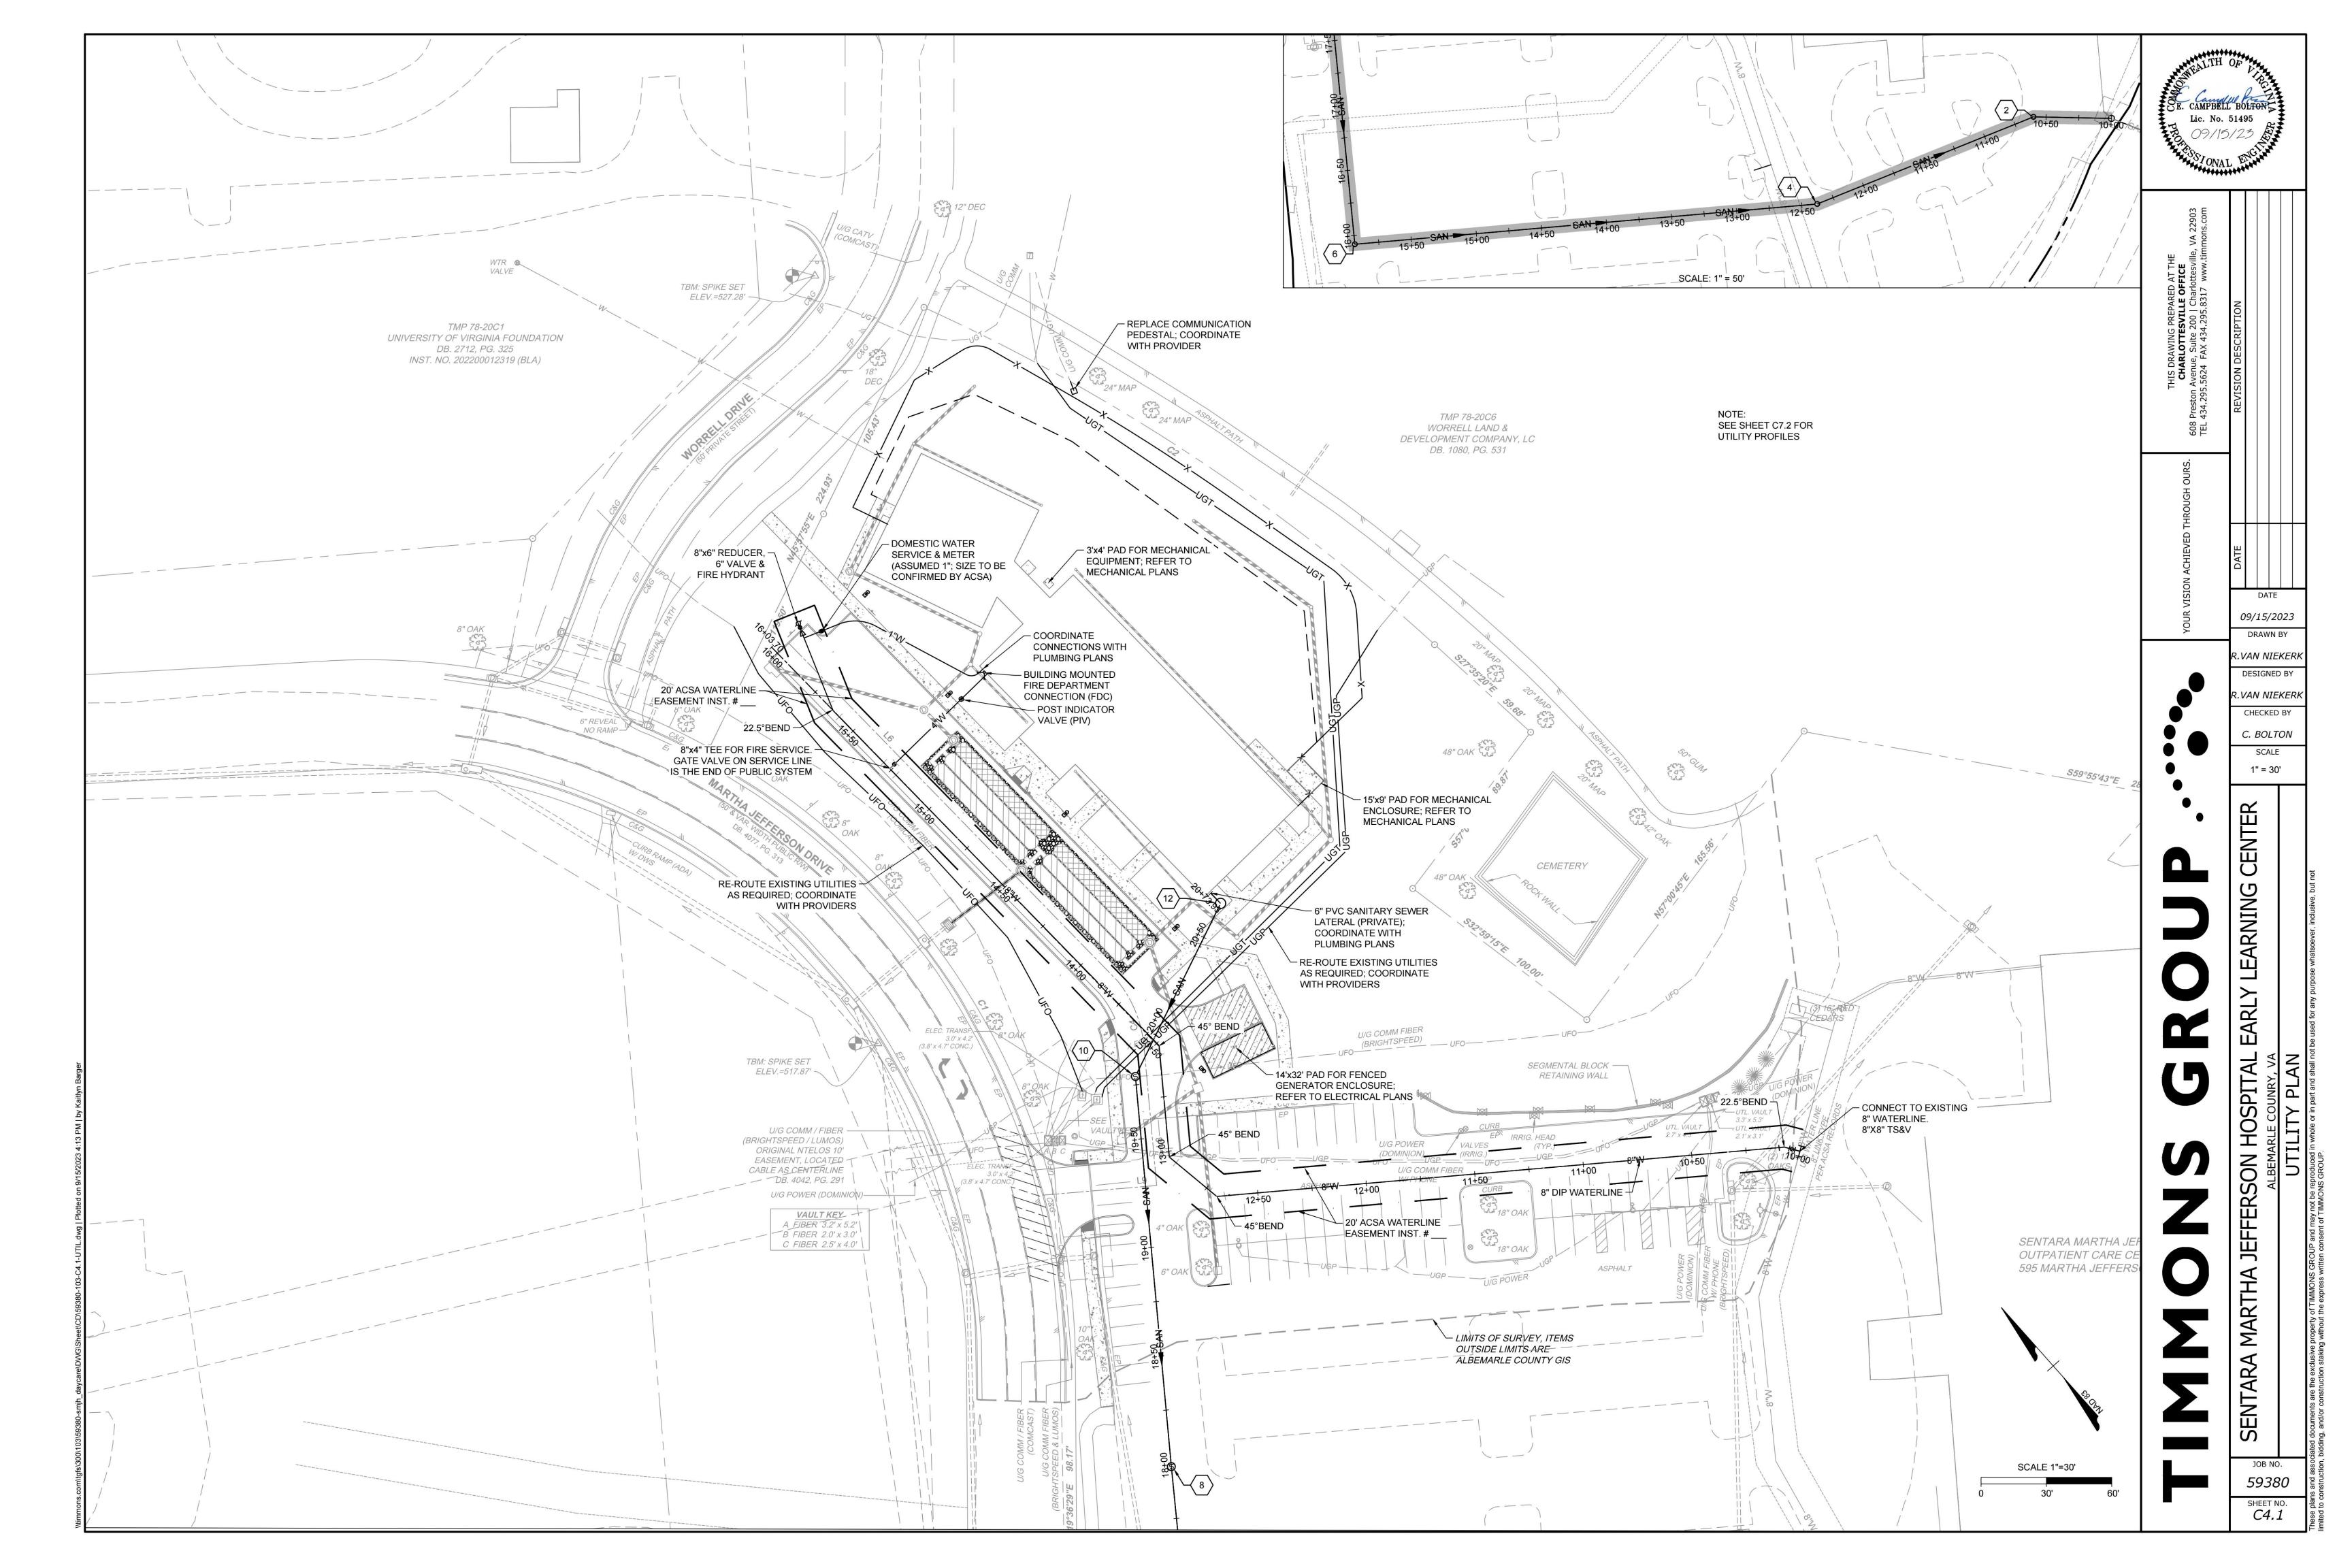
59380 SHEET NO. C0.4














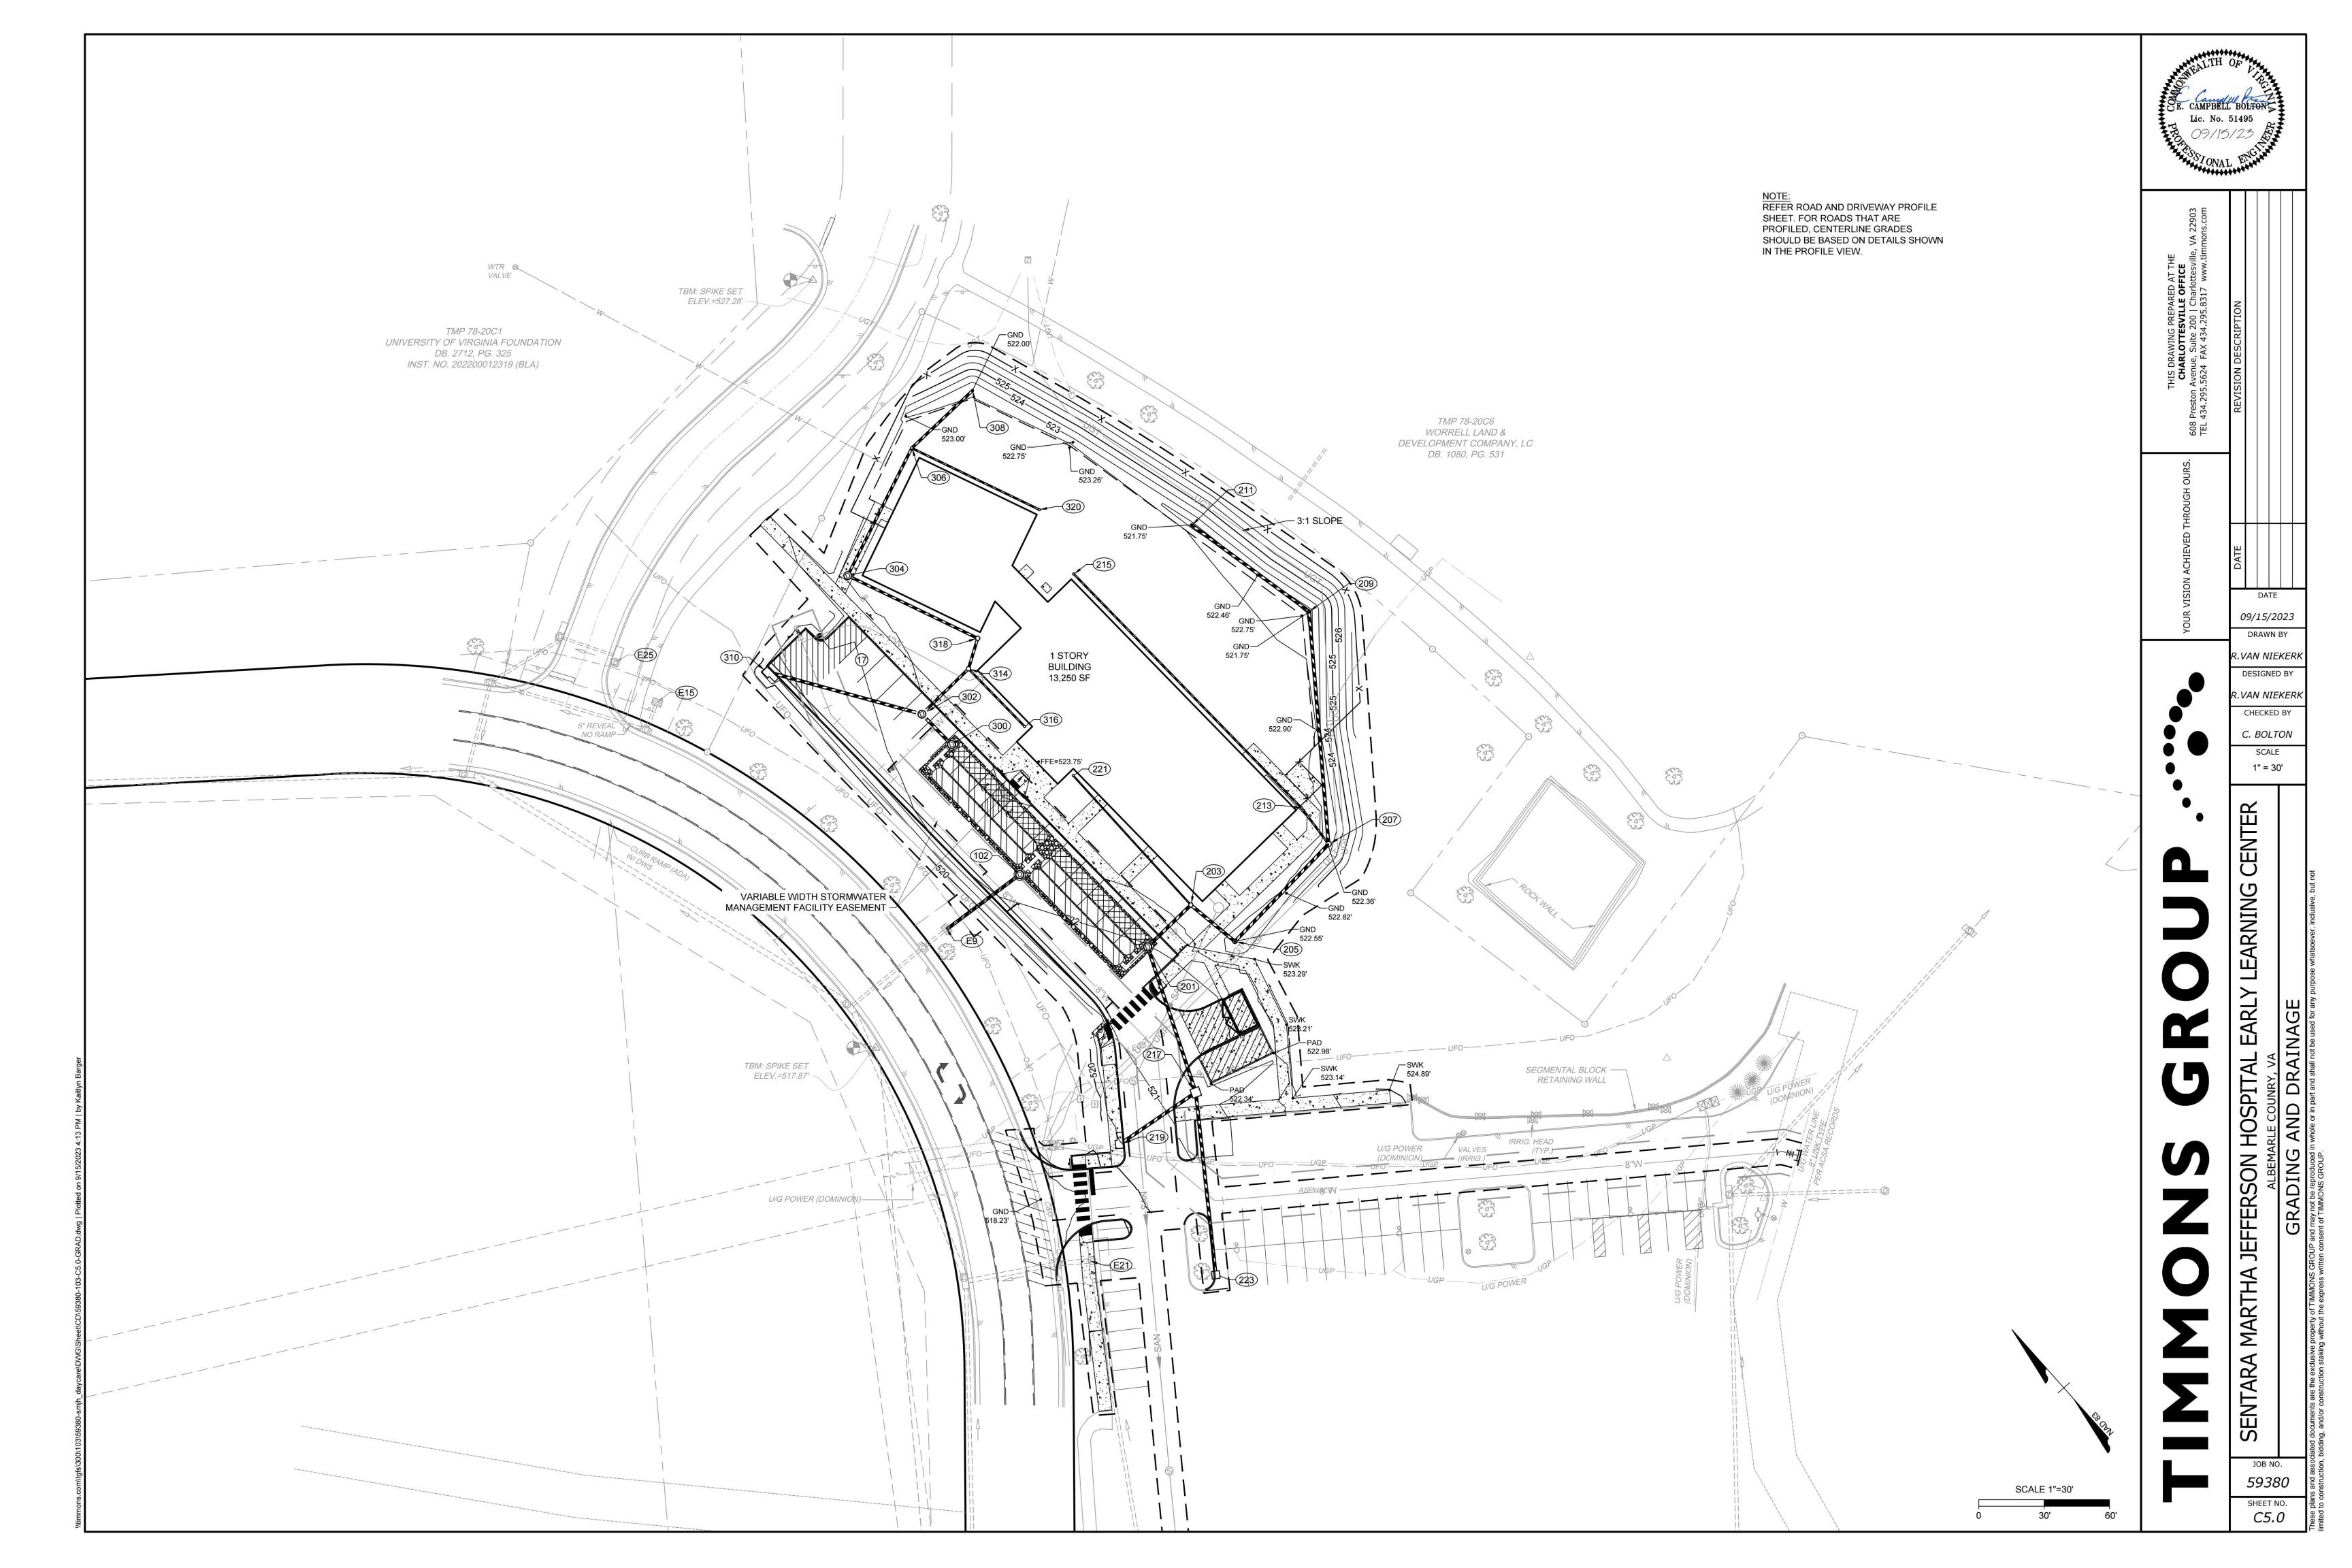

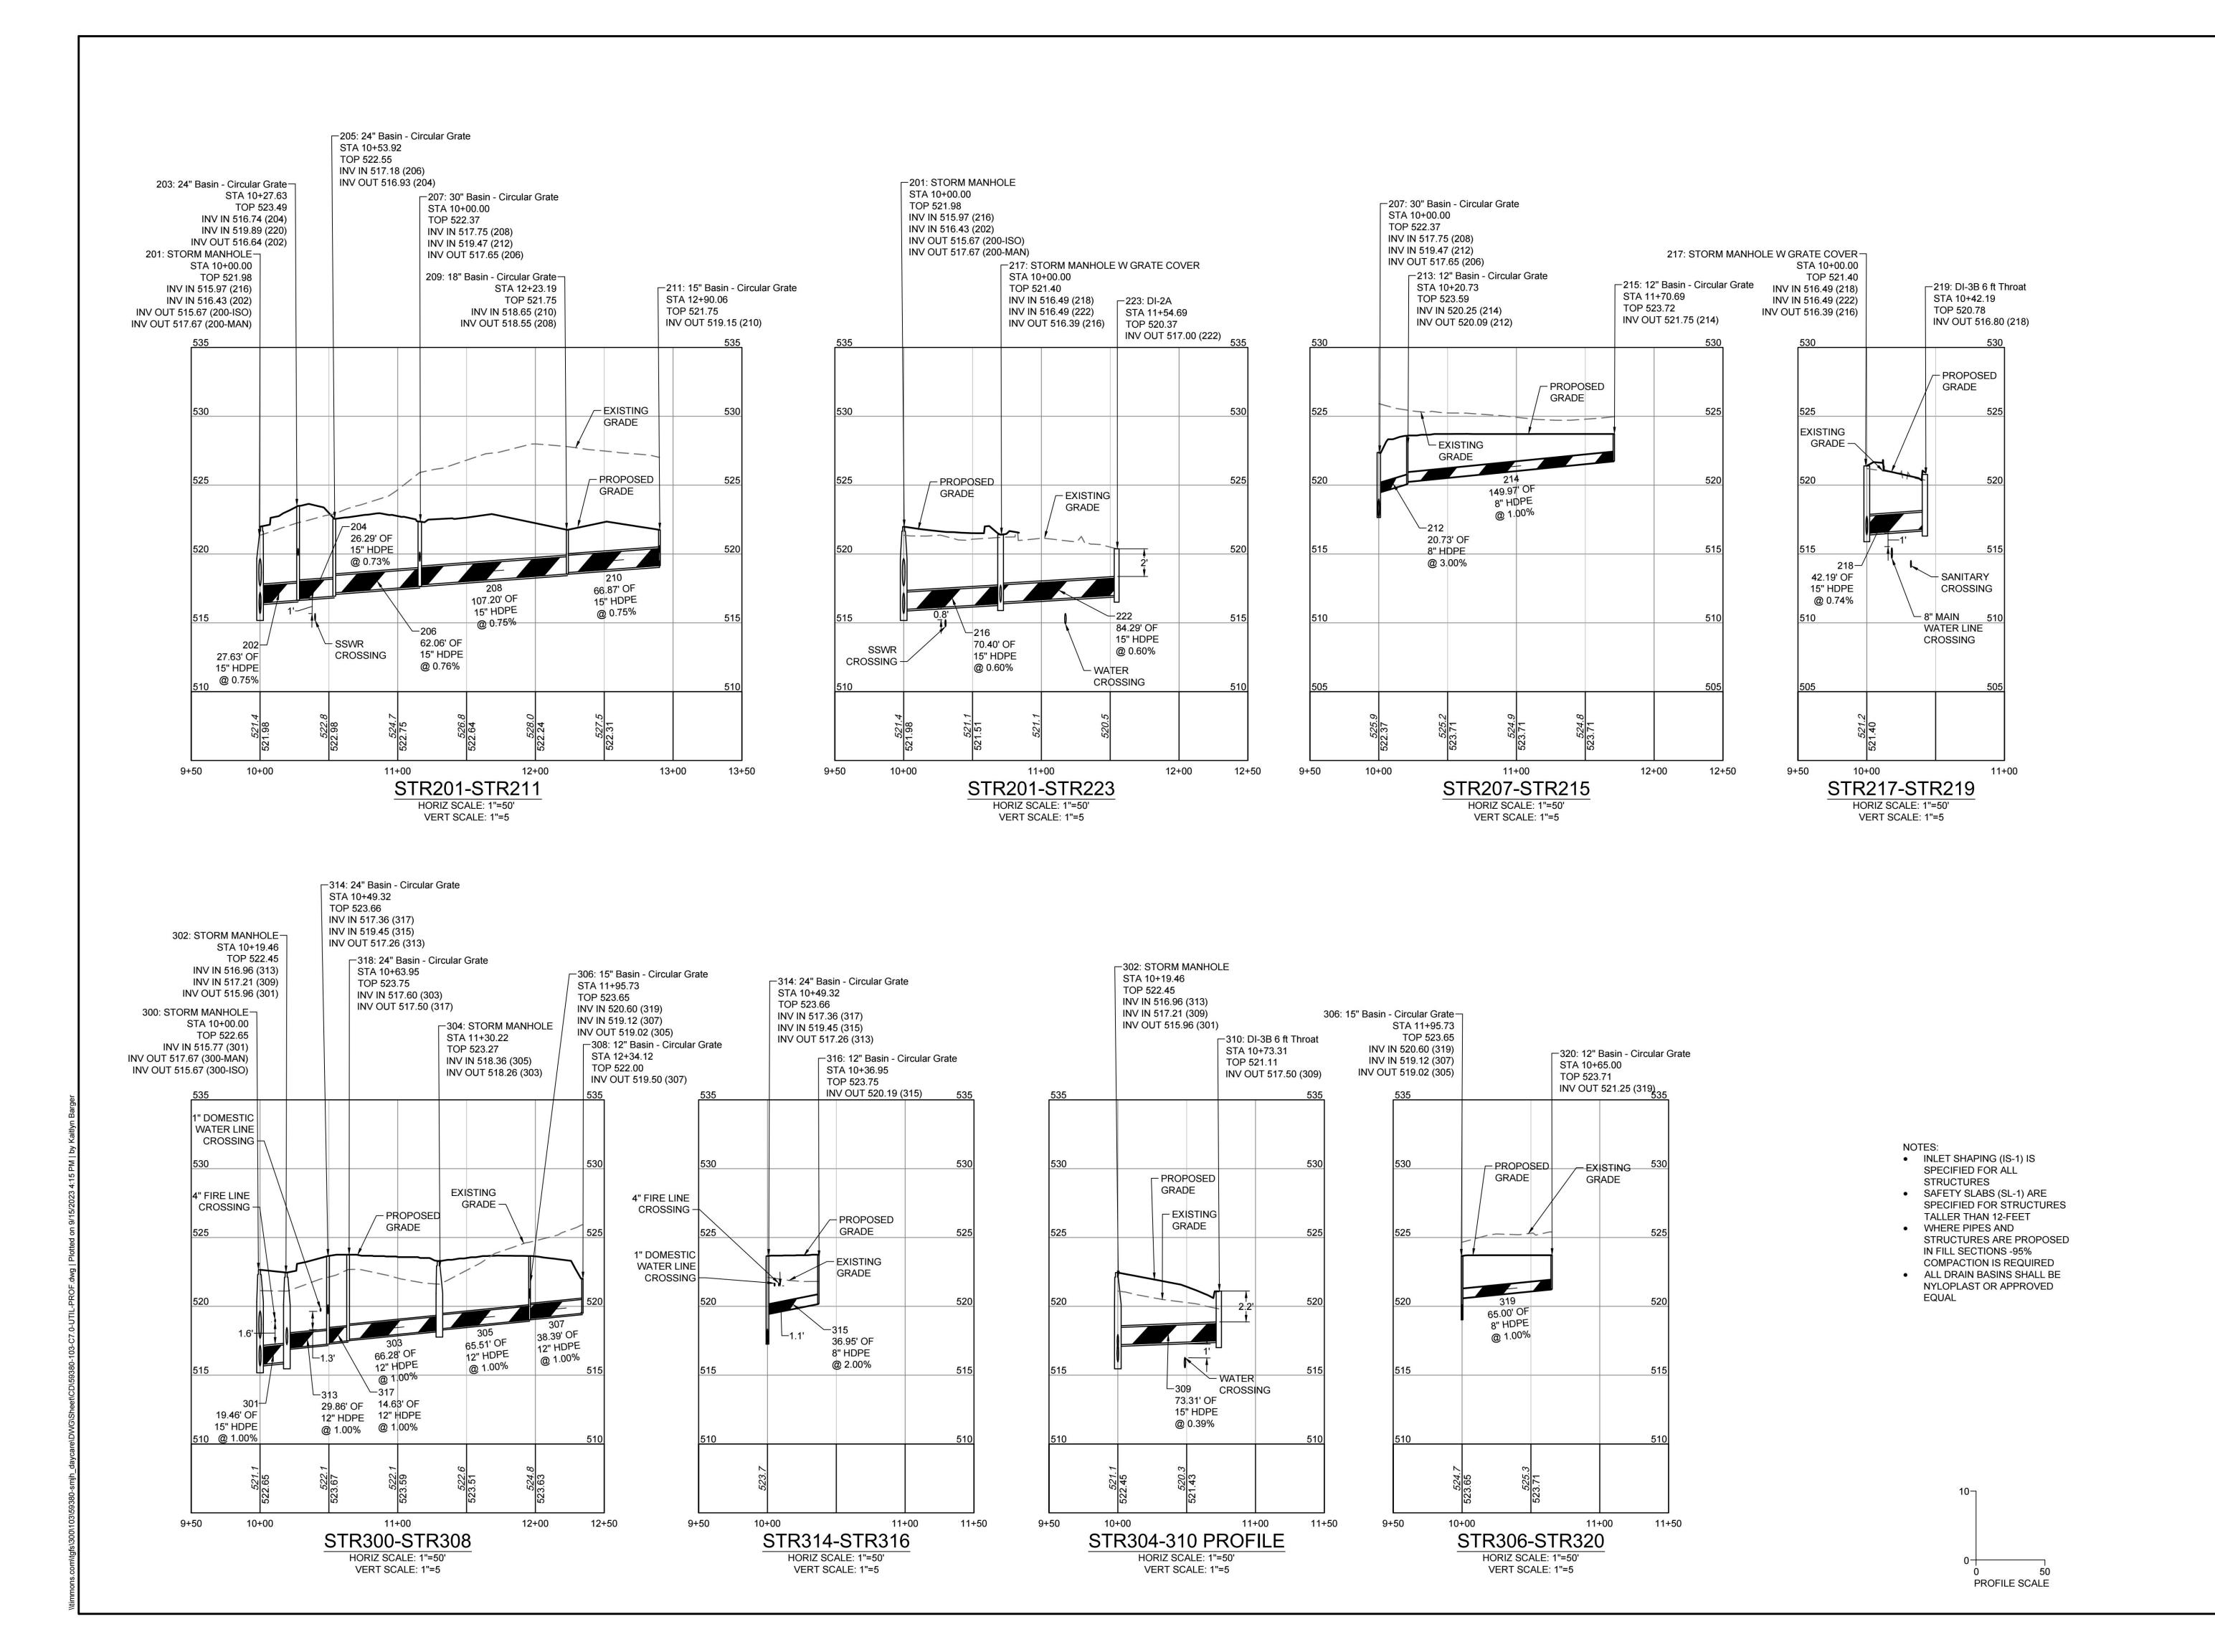

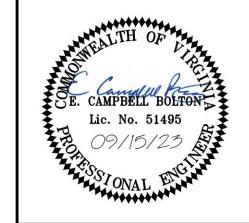

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DATE 09/15/2023 DRAWN BY

VAN NIEKERK **DESIGNED BY** .VAN NIEKERK CHECKED BY

C. BOLTON SCALE H:1" = 50' V:1" = 10'

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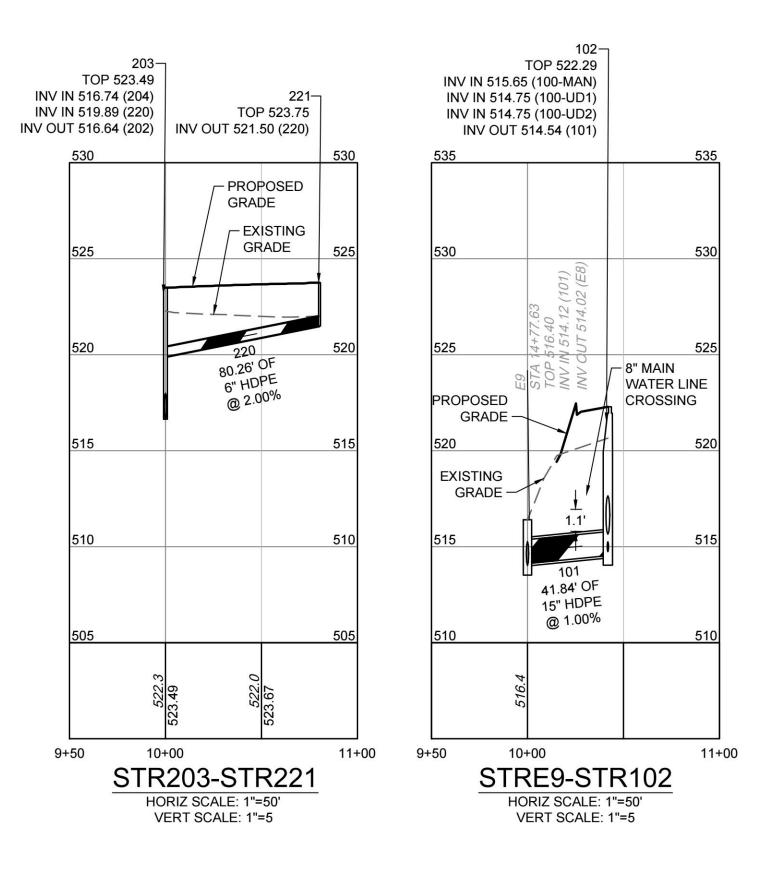
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JOB NO. 59380

SHEET NO. C7.0



| STORM PIPE TABLE | | | | | | | | |
|------------------|-----|-----------|--------------------|----------------------|-------|----------|-------------|--|
| PIPE# | DIA | FROM - TO | UPSTREAM INVERT | DOWNSTREAM INVERT | SLOPE | LENGTH | DESCRIPTION | |
| 101 | 15" | 102 - E9 | 514.54 | 514.12 | 1.00% | 41.84 LF | 15" HDPE | |
| | | ž: | | | • | žo. | 93 | |

| <u>r</u> | | | | | | | | | |
|-------------|-----------------------|------------------|-----------------------------|--|--|--|--|--|--|
| | STORM STRUCTURE TABLE | | | | | | | | |
| STRUCTURE # | ТОР | STRUCTURE HEIGHT | DESCRIPTION | | | | | | |
| 200-MAN | 521.70 | 4.03' | 6 " Cleanout | | | | | | |
| 201 | 521.98 | 6.31' | STORM MANHOLE | | | | | | |
| 203 | 523.49 | 6.85' | 24" Basin - Circular Grate | | | | | | |
| 205 | 522.55 | 5.62' | 24" Basin - Circular Grate | | | | | | |
| 207 | 522.37 | 4.72' | 30" Basin - Circular Grate | | | | | | |
| 209 | 521.75 | 3.20' | 18" Basin - Circular Grate | | | | | | |
| 211 | 521.75 | 2.60' | 15" Basin - Circular Grate | | | | | | |
| 213 | 523.59 | 3.50' | 12" Basin - Circular Grate | | | | | | |
| 215 | 523.72 | 1.97' | 12" Basin - Circular Grate | | | | | | |
| 217 | 521.40 | 5.01' | STORM MANHOLE W GRATE COVER | | | | | | |
| 219 | 520.78 | 3.98' | DI-3B 6 ft Throat | | | | | | |
| 221 | 523.75 | 2.25' | 12" Basin - Circular Grate | | | | | | |
| 223 | 520.37 | 3.37' | DI-2A | | | | | | |

| STORM PIPE TABLE | | | | | | | | | | | |
|------------------|-----|---------------|--------------------|----------------------|-------|-----------|-------------|--|--|--|--|
| PIPE# | DIA | FROM - TO | UPSTREAM INVERT | DOWNSTREAM INVERT | SLOPE | LENGTH | DESCRIPTION | | | | |
| 200-ISO | 18" | 201 - 200-ISO | 515.67 | 515.67 | 0.00% | 6.09 LF | 18" HDPE | | | | |
| 200-MAN | 24" | 201 - 200-MAN | 517.67 | 517.67 | 0.00% | 13.91 LF | 24" HDPE | | | | |
| 202 | 15" | 203 - 201 | 516.64 | 516.43 | 0.75% | 27.63 LF | 15" HDPE | | | | |
| 204 | 15" | 205 - 203 | 516.93 | 516.74 | 0.73% | 26.29 LF | 15" HDPE | | | | |
| 206 | 15" | 207 - 205 | 517.65 | 517.18 | 0.76% | 62.06 LF | 15" HDPE | | | | |
| 208 | 15" | 209 - 207 | 518.55 | 517.75 | 0.75% | 107.20 LF | 15" HDPE | | | | |
| 210 | 15" | 211 - 209 | 519.15 | 518.65 | 0.75% | 66.87 LF | 15" HDPE | | | | |
| 212 | 8" | 213 - 207 | 520.09 | 519.47 | 3.00% | 20.73 LF | 8" HDPE | | | | |
| 214 | 8" | 215 - 213 | 521.75 | 520.25 | 1.00% | 149.97 LF | 8" HDPE | | | | |
| 216 | 15" | 217 - 201 | 516.39 | 515.97 | 0.60% | 70.40 LF | 15" HDPE | | | | |
| 218 | 15" | 219 - 217 | 516.80 | 516.49 | 0.74% | 42.19 LF | 15" HDPE | | | | |
| 220 | 6" | 221 - 203 | 521.50 | 519.89 | 2.00% | 80.26 LF | 6" HDPE | | | | |
| 222 | 15" | 223 - 217 | 517.00 | 516.49 | 0.60% | 84.29 LF | 15" HDPE | | | | |

NOTES:

INLET SHAPING (IS-1) IS
 SPECIFIED FOR ALL
 STRUCTURES

WHERE PIPES AND

EQUAL

 SAFETY SLABS (SL-1) ARE SPECIFIED FOR STRUCTURES TALLER THAN 12-FEET

IN FILL SECTIONS -95% COMPACTION IS REQUIRED ALL DRAIN BASINS SHALL BE NYLOPLAST OR APPROVED

STRUCTURES ARE PROPOSED

| | STORM PIPE TABLE | | | | | | | | | | |
|---------|------------------|---------------|--------------------|----------------------|-------|----------|-------------|--|--|--|--|
| PIPE# | DIA | FROM - TO | UPSTREAM INVERT | DOWNSTREAM INVERT | SLOPE | LENGTH | DESCRIPTION | | | | |
| 300-ISO | 18" | 300 - 300-ISO | 515.67 | 515.67 | 0.00% | 6.13 LF | 18" HDPE | | | | |
| 300-MAN | 24" | 300 - 300-MAN | 517.67 | 517.67 | 0.00% | 13.89 LF | 24" HDPE | | | | |
| 301 | 15" | 302 - 300 | 515.96 | 515.77 | 1.00% | 19.46 LF | 15" HDPE | | | | |
| 303 | 12" | 304 - 318 | 518.26 | 517.60 | 1.00% | 66.28 LF | 12" HDPE | | | | |
| 305 | 12" | 306 - 304 | 519.02 | 518.36 | 1.00% | 65.51 LF | 12" HDPE | | | | |
| 307 | 12" | 308 - 306 | 519.50 | 519.12 | 1.00% | 38.39 LF | 12" HDPE | | | | |
| 309 | 15" | 310 - 302 | 517.50 | 517.21 | 0.39% | 73.31 LF | 15" HDPE | | | | |
| 313 | 12" | 314 - 302 | 517.26 | 516.96 | 1.00% | 29.86 LF | 12" HDPE | | | | |
| 315 | 8" | 316 - 314 | 520.19 | 519.45 | 2.00% | 36.95 LF | 8" HDPE | | | | |
| 317 | 12" | 318 - 314 | 517.50 | 517.36 | 1.00% | 14.63 LF | 12" HDPE | | | | |
| 319 | 8" | 320 - 306 | 521.25 | 520.60 | 1.00% | 65.00 LF | 8" HDPE | | | | |

| 5 | | | | | | | | |
|-----------------------|--------|------------------|------------------------------------|--|--|--|--|--|
| STORM STRUCTURE TABLE | | | | | | | | |
| STRUCTURE# | ТОР | STRUCTURE HEIGHT | DESCRIPTION | | | | | |
| E9 | 516.40 | 2.38' | EXISTING INLET | | | | | |
| 102 | 522.29 | 7.75' | DETENTION SYSTEM CONTROL STRUCTURE | | | | | |

| STORM STRUCTURE TABLE | | | | | | | |
|-----------------------|--------|------------------|----------------------------|--|--|--|--|
| STRUCTURE # | ТОР | STRUCTURE HEIGHT | DESCRIPTION | | | | |
| 300 | 522.65 | 6.98' | STORM MANHOLE | | | | |
| 300-ISO | 522.72 | 7.05' | 6 " Cleanout | | | | |
| 302 | 522.45 | 6.49' | STORM MANHOLE | | | | |
| 304 | 523.27 | 5.01' | STORM MANHOLE | | | | |
| 306 | 523.65 | 4.63' | 15" Basin - Circular Grate | | | | |
| 308 | 522.00 | 2.50' | 12" Basin - Circular Grate | | | | |
| 310 | 521.11 | 3.61' | DI-3B 6 ft Throat | | | | |
| 314 | 523.66 | 6.40' | 24" Basin - Circular Grate | | | | |
| 316 | 523.75 | 3.56' | 12" Basin - Circular Grate | | | | |
| 318 | 523.75 | 6.25' | 24" Basin - Circular Grate | | | | |
| 320 | 523.71 | 2.46' | 12" Basin - Circular Grate | | | | |

| | STORM PIPE TABLE | | | | | | | | | | |
|---|------------------|---------------|--------------------|----------------------|-------|----------|-------------|--|--|--|--|
| | DIA | FROM - TO | UPSTREAM INVERT | DOWNSTREAM INVERT | SLOPE | LENGTH | DESCRIPTION | | | | |
| | 18" | 300 - 300-ISO | 515.67 | 515.67 | 0.00% | 6.13 LF | 18" HDPE | | | | |
| 1 | 24" | 300 - 300-MAN | 517.67 | 517.67 | 0.00% | 13.89 LF | 24" HDPE | | | | |
| | 15" | 302 - 300 | 515.96 | 515.77 | 1.00% | 19.46 LF | 15" HDPE | | | | |
| | 12" | 304 - 318 | 518.26 | 517.60 | 1.00% | 66.28 LF | 12" HDPE | | | | |
| | 12" | 306 - 304 | 519.02 | 518.36 | 1.00% | 65.51 LF | 12" HDPE | | | | |
| | 12" | 308 - 306 | 519.50 | 519.12 | 1.00% | 38.39 LF | 12" HDPE | | | | |
| | 15" | 310 - 302 | 517.50 | 517.21 | 0.39% | 73.31 LF | 15" HDPE | | | | |
| | 12" | 314 - 302 | 517.26 | 516.96 | 1.00% | 29.86 LF | 12" HDPE | | | | |
| | 8" | 316 - 314 | 520.19 | 519.45 | 2.00% | 36.95 LF | 8" HDPE | | | | |
| | 12" | 318 - 314 | 517.50 | 517.36 | 1.00% | 14.63 LF | 12" HDPE | | | | |

| 10- |] | |
|-----|-------------|--------|
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| | PROFILE SCA | |

09/15/2023 DRAWN BY R.VAN NIEKERK DESIGNED BY R.VAN NIEKERK CHECKED BY


C. BOLTON SCALE H:1" = 50' V:1" = 10'


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JEFFERSON HOSPITAL

59380 SHEET NO. C7.1



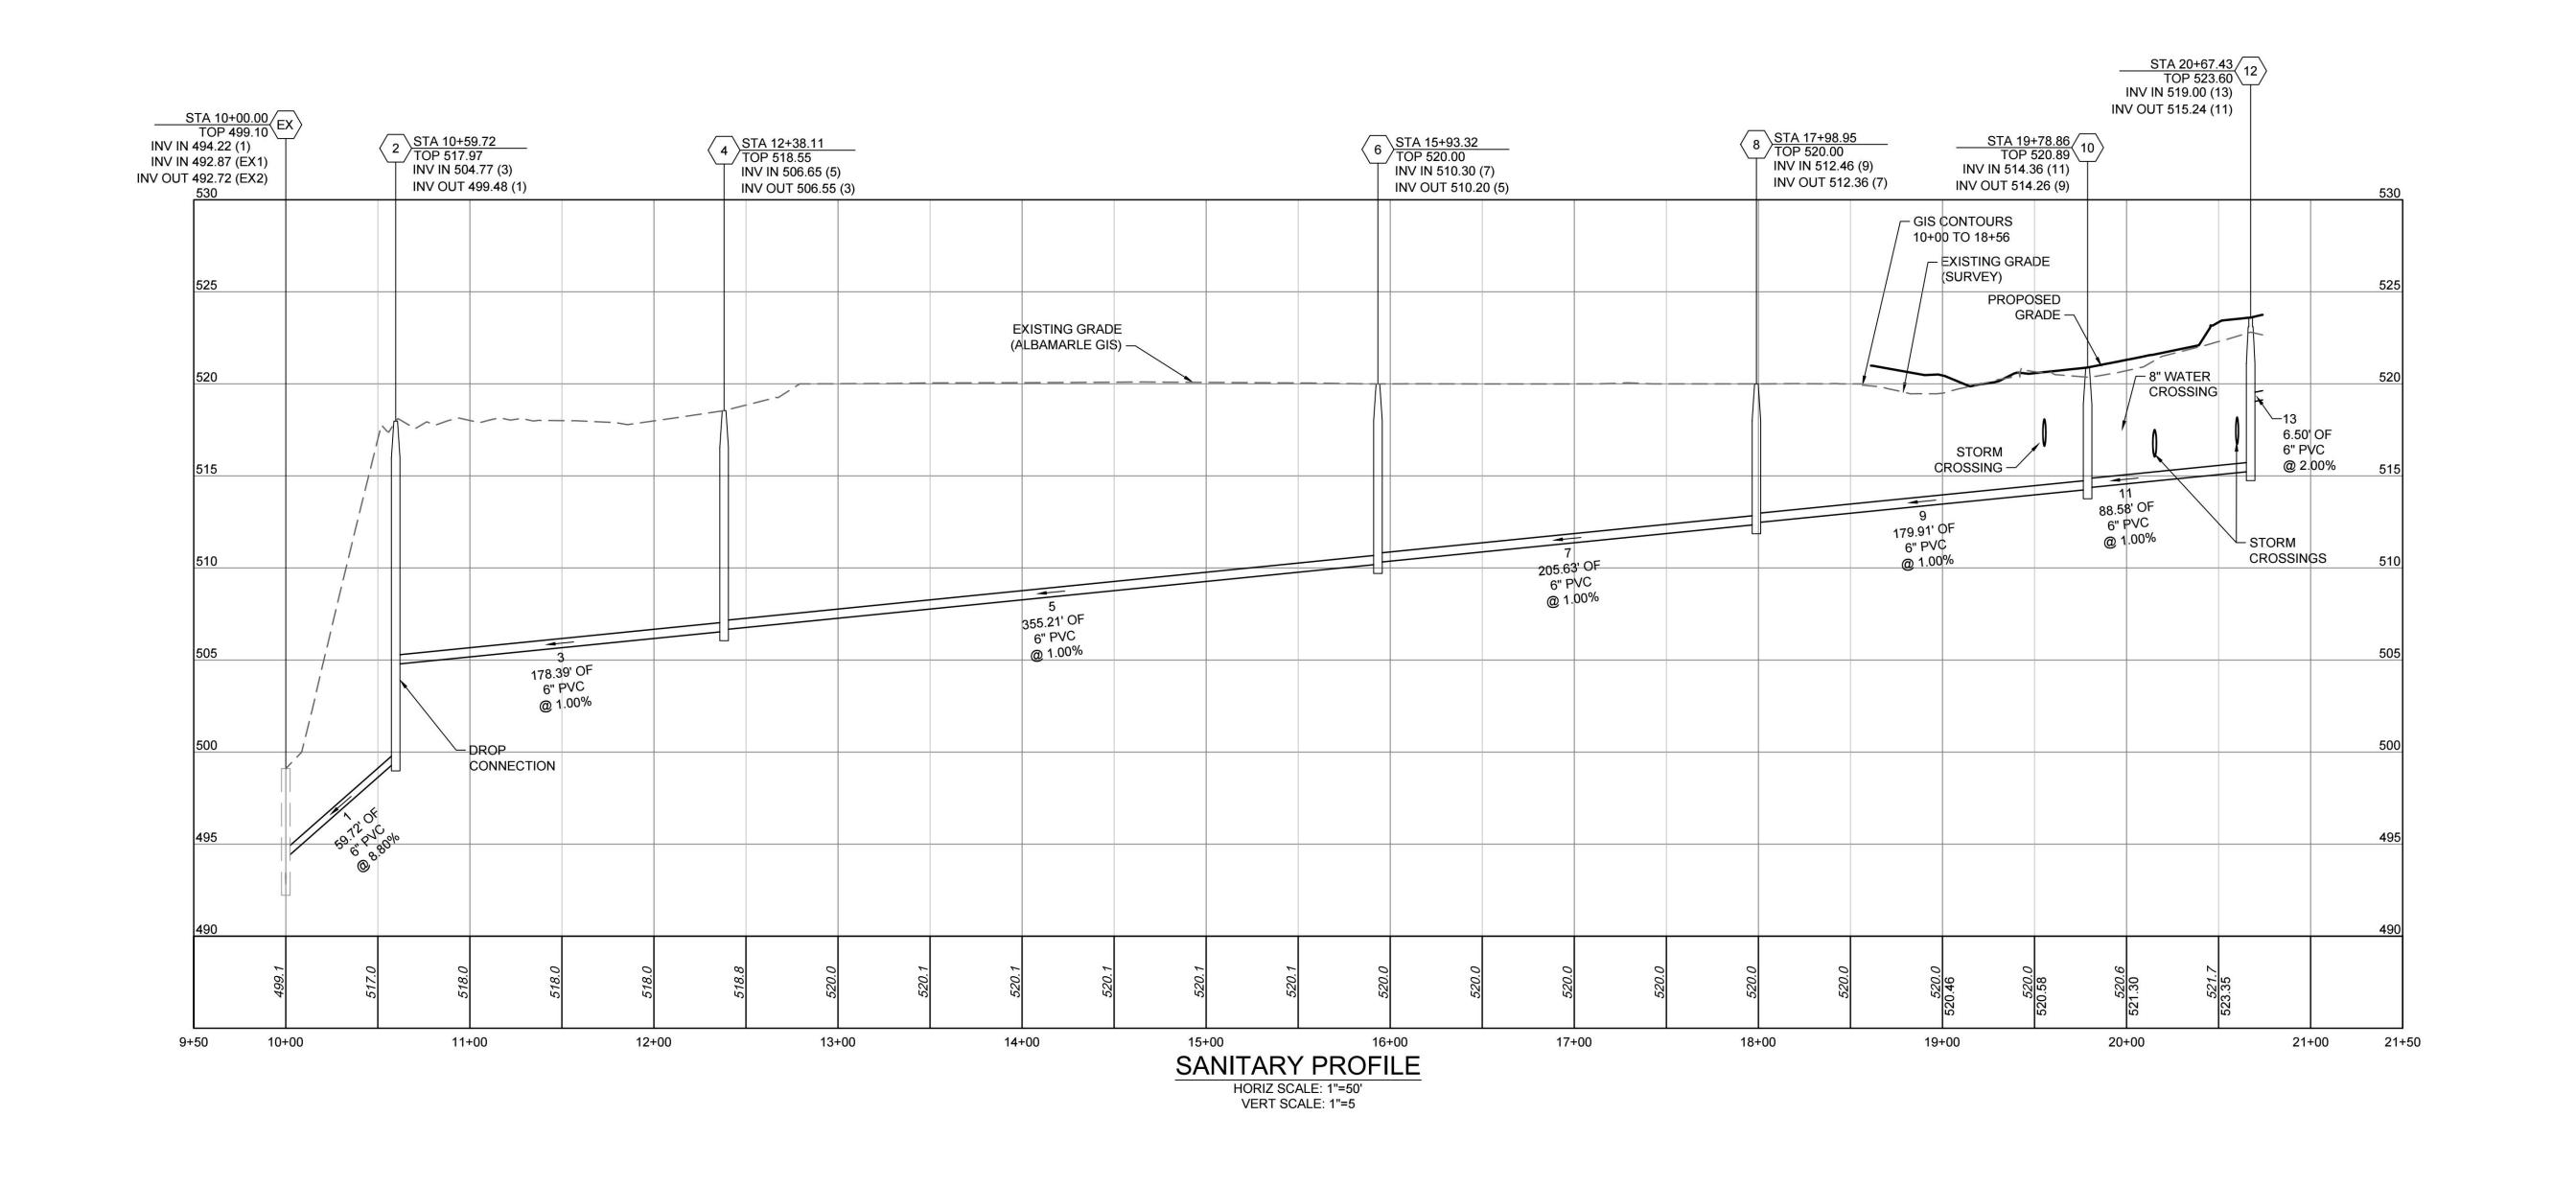

| PIPE TABLE | | | | | | | |
|------------|------|-----------|-------|---------------|--|--|--|
| PIPE NAME | SIZE | LENGTH | SLOPE | BEARING | | | |
| 9 | 6" | 179.91 LF | 1.00% | S14° 44' 16"W | | | |
| 5 | 6" | 355.21 LF | 1.00% | S74° 58' 22"E | | | |
| 3 | 6" | 178.39 LF | 1.00% | N88° 02' 39"E | | | |
| 1 | 6" | 59.72 LF | 8.80% | S68° 51' 34"E | | | |
| 7 | 6" | 205.63 LF | 1.00% | S14° 21' 04"W | | | |
| 13 | 6" | 6.50 LF | 2.00% | S24° 14' 01"E | | | |
| 11 | 6" | 88.58 LF | 1.00% | S46° 12' 33"W | | | |
| EX1 | 8" | 7.99 LF | 0.00% | S28° 04' 27"E | | | |
| EX2 | 6" | 95.68 LF | 0.91% | S48° 49' 04"E | | | |

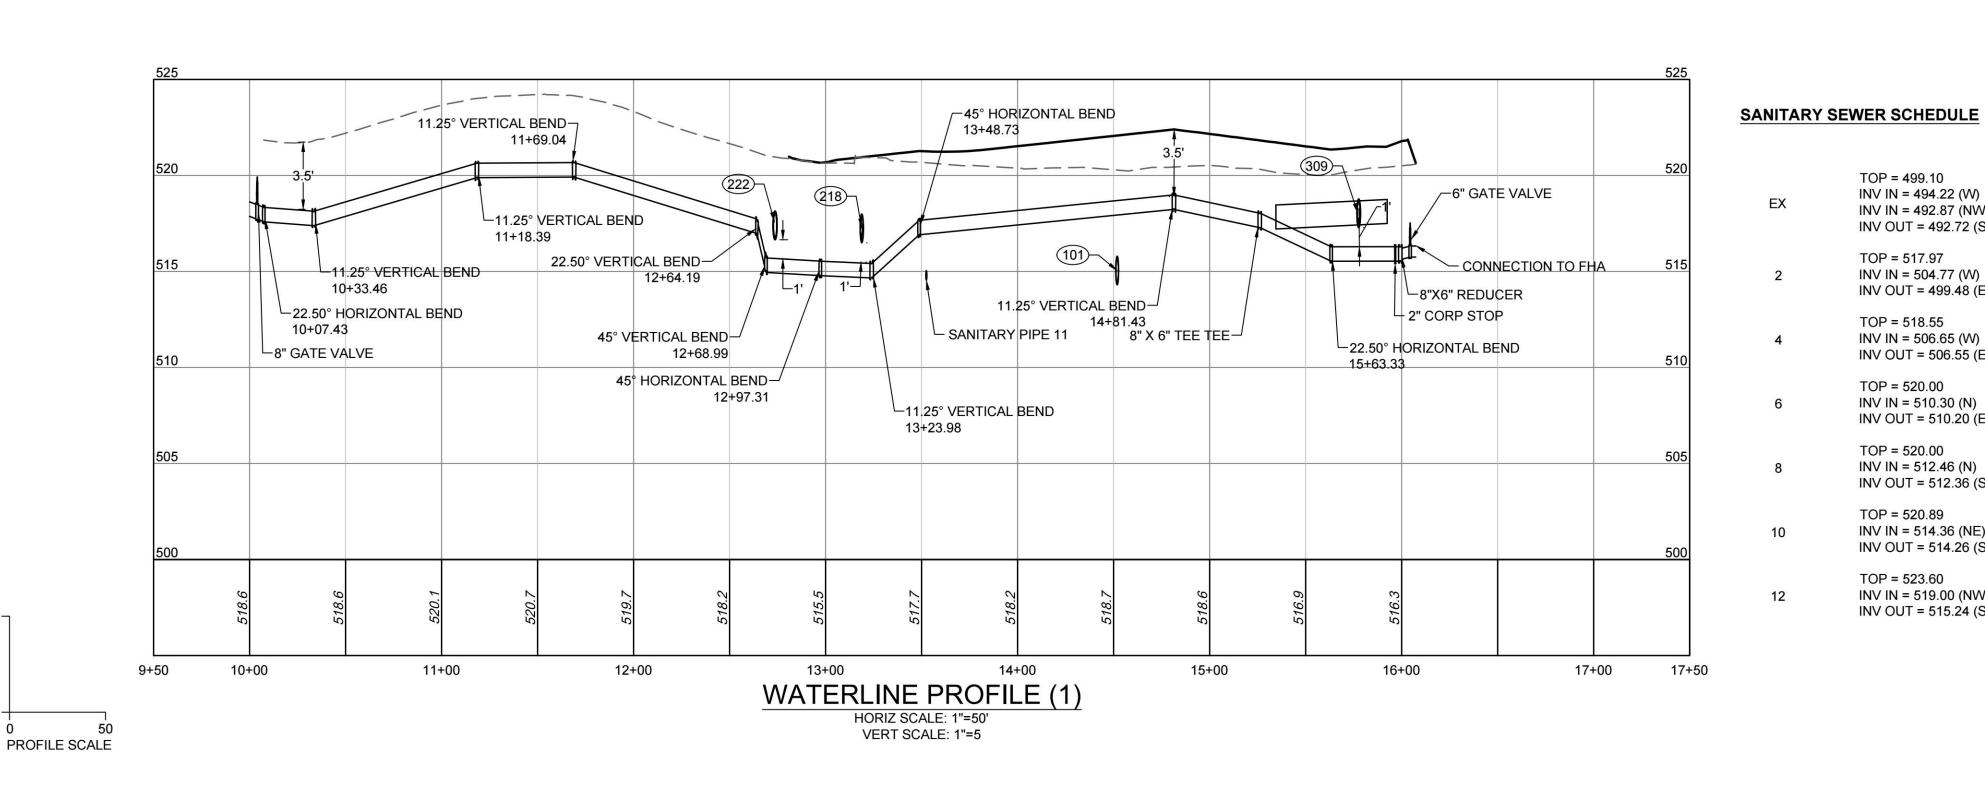TOP = 499.10

TOP = 517.97

TOP = 518.55

TOP = 520.00

TOP = 520.00INV IN = 512.46 (N) INV OUT = 512.36 (S)

TOP = 520.89INV IN = 514.36 (NE) INV OUT = 514.26 (S)

TOP = 523.60INV IN = 519.00 (NW) INV OUT = 515.24 (SW)

INV IN = 504.77 (W)

INV IN = 506.65 (W)

INV IN = 510.30 (N)

INV OUT = 510.20 (E)

INV OUT = 506.55 (E)

INV OUT = 499.48 (E)

INV IN = 494.22 (W)

INV IN = 492.87 (NW)

INV OUT = 492.72 (SE)

| SEWER STRUCTURE TABLE | | | | | | | | |
|-----------------------|--------|------------------|-------------|--|--|--|--|--|
| STRUCTURE # | TOP | STRUCTURE HEIGHT | DESCRIPTION | | | | | |
| EX | 499.10 | 6.38' | EX MH | | | | | |
| 2 | 517.97 | 18.50' | 48" DROP MH | | | | | |
| 4 | 518.55 | 12.00' | 48" Manhole | | | | | |
| 6 | 520.00 | 9.80' | 48" Manhole | | | | | |
| 8 | 520.00 | 7.64' | 48" Manhole | | | | | |
| 10 | 520.89 | 6.63' | 48" Manhole | | | | | |
| 12 | 523.60 | 8.36' | 48" Manhole | | | | | |

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5.5624 FAX 434.295.8317 www.t

DATE

09/15/2023 DRAWN BY .VAN NIEKERK DESIGNED BY

R.VAN NIEKERK CHECKED BY C. BOLTON

SCALE H:1" = 50' V:1" = 10'

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INLET SHAPING (IS-1) IS SPECIFIED

SPECIFIED FOR STRUCTURES

WHERE PIPES AND STRUCTURES

ARE PROPOSED IN FILL SECTIONS

-95% COMPACTION IS REQUIRED

INSTALLATIONS SHALL COMPLY

WITH ACSA STANDARDS EVEN

THOUGH SYSTEM SHALL BE

FOR ALL STRUCTURES

TALLER THAN 12-FEET


SAFETY SLABS (SL-1) ARE


ALL SANITARY SEWER

PRIVATE.

JEFFERS(

JOB NO. 59380 SHEET NO. C7.2

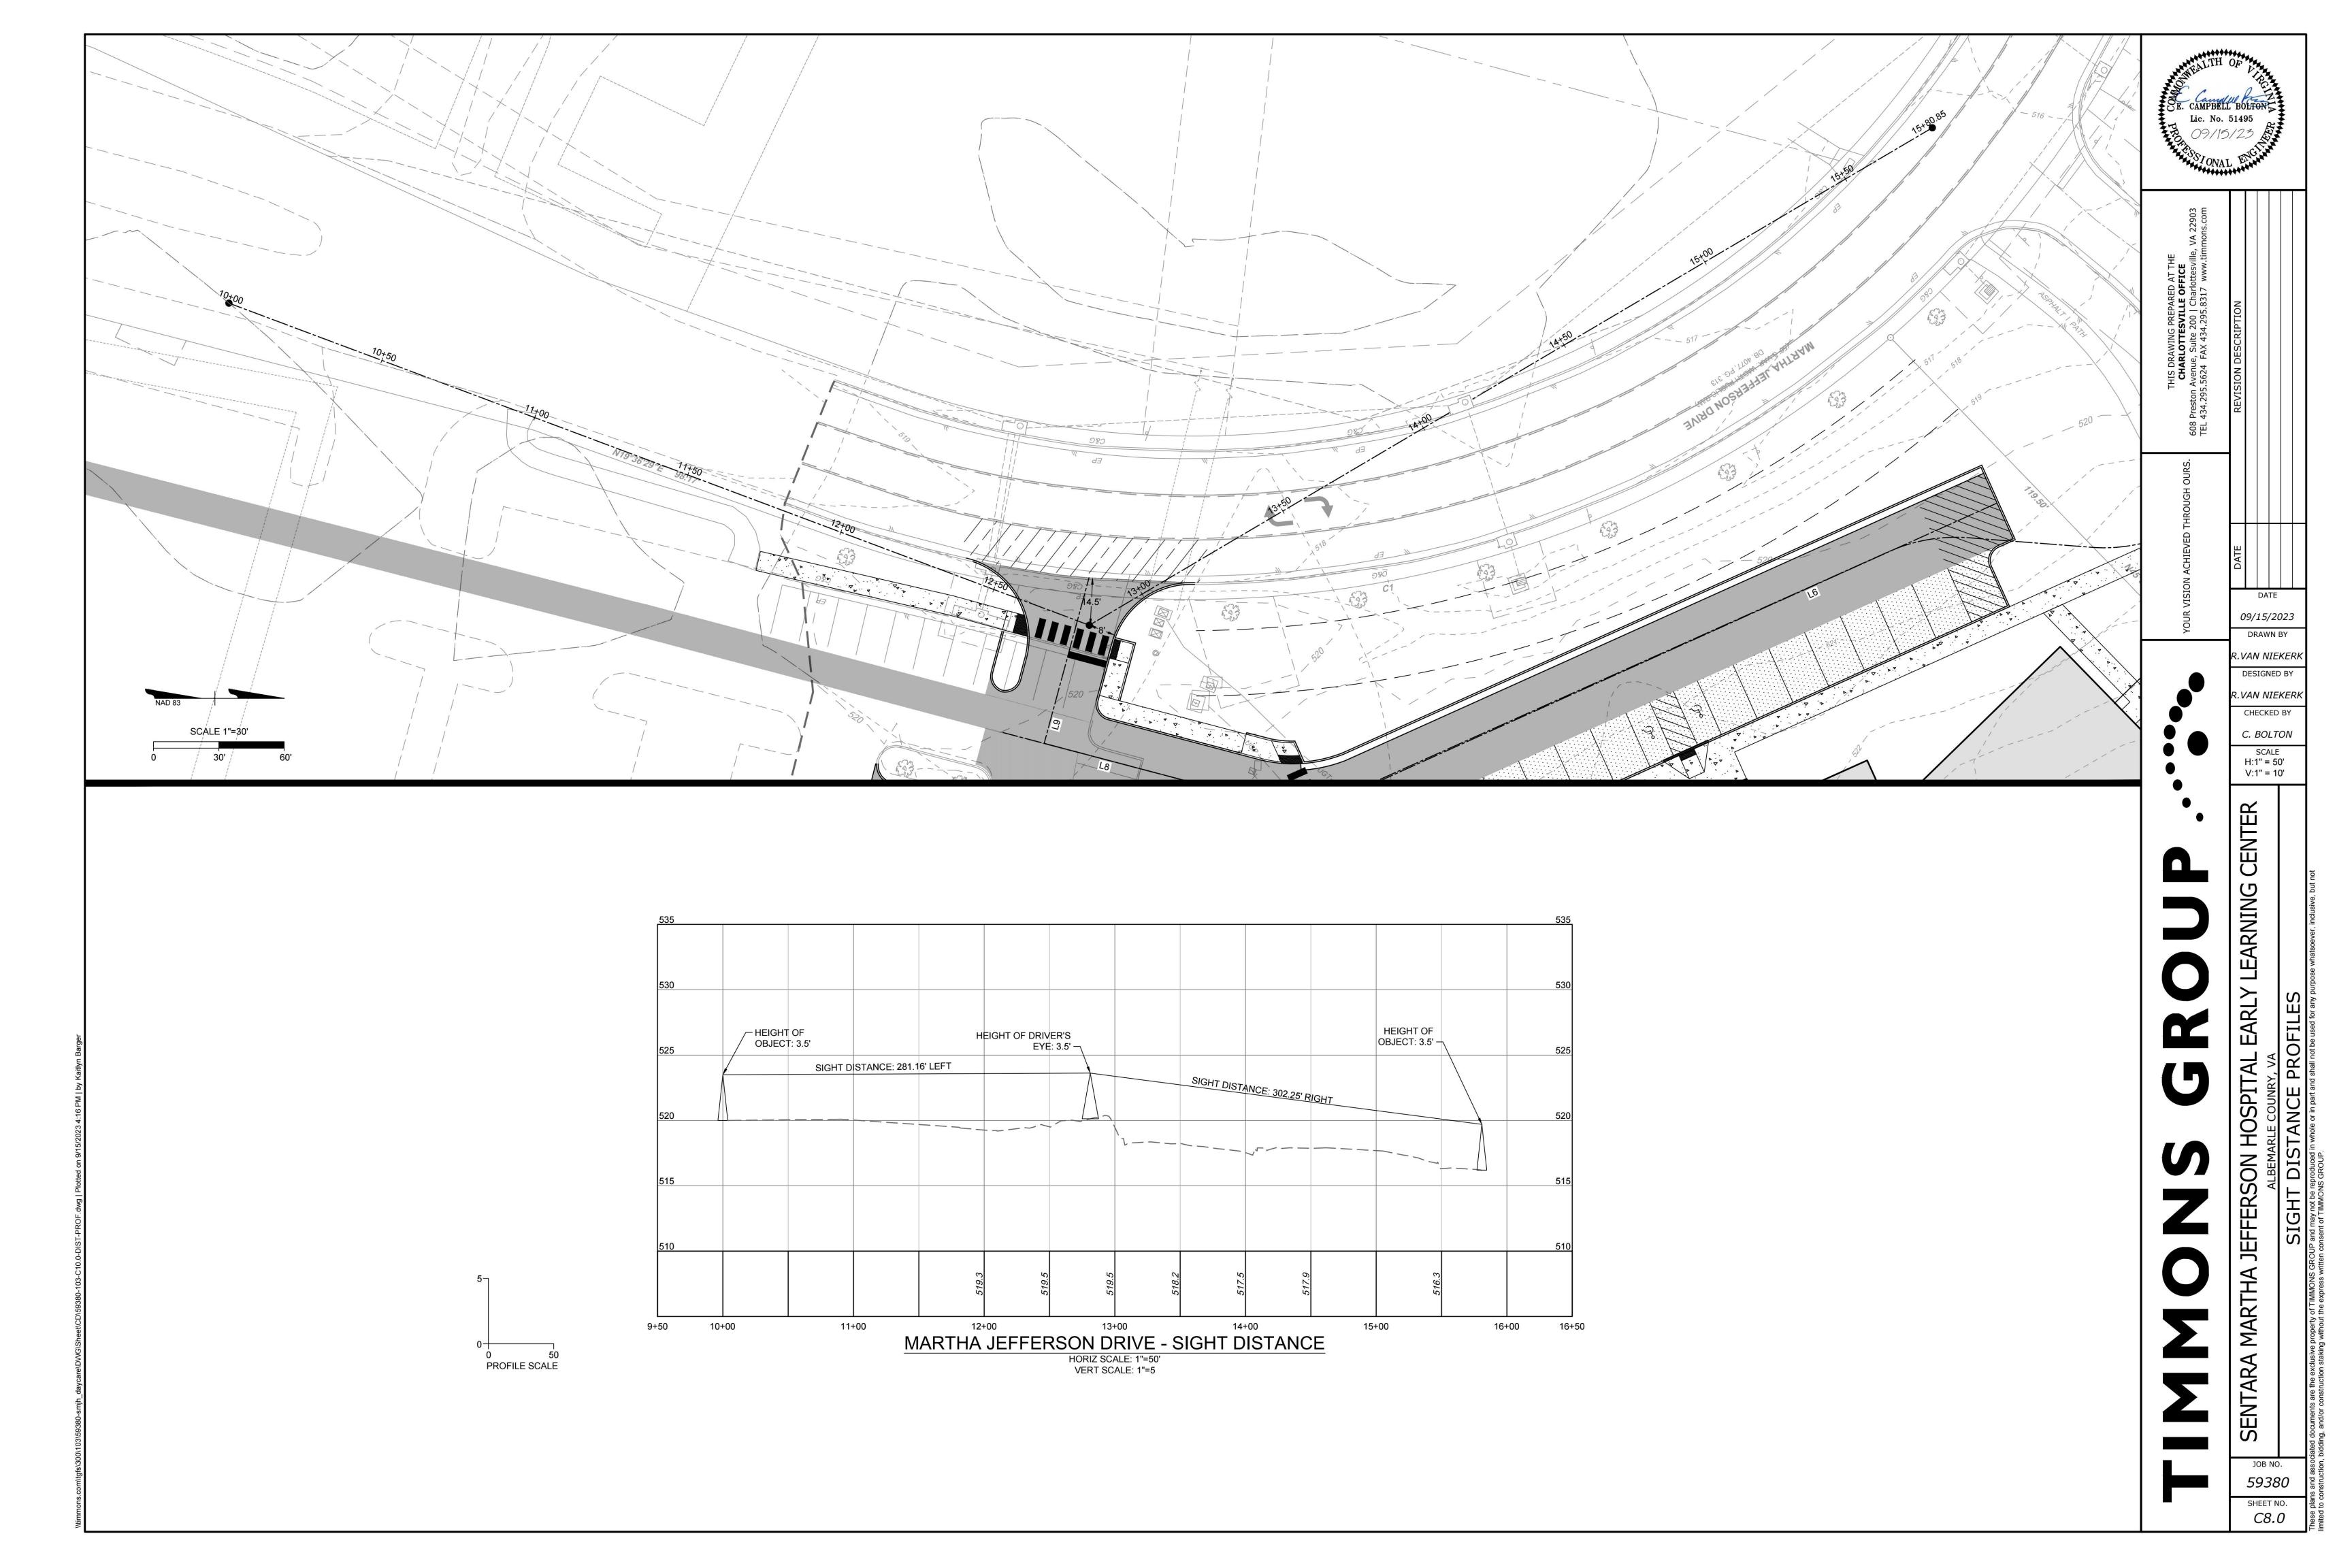

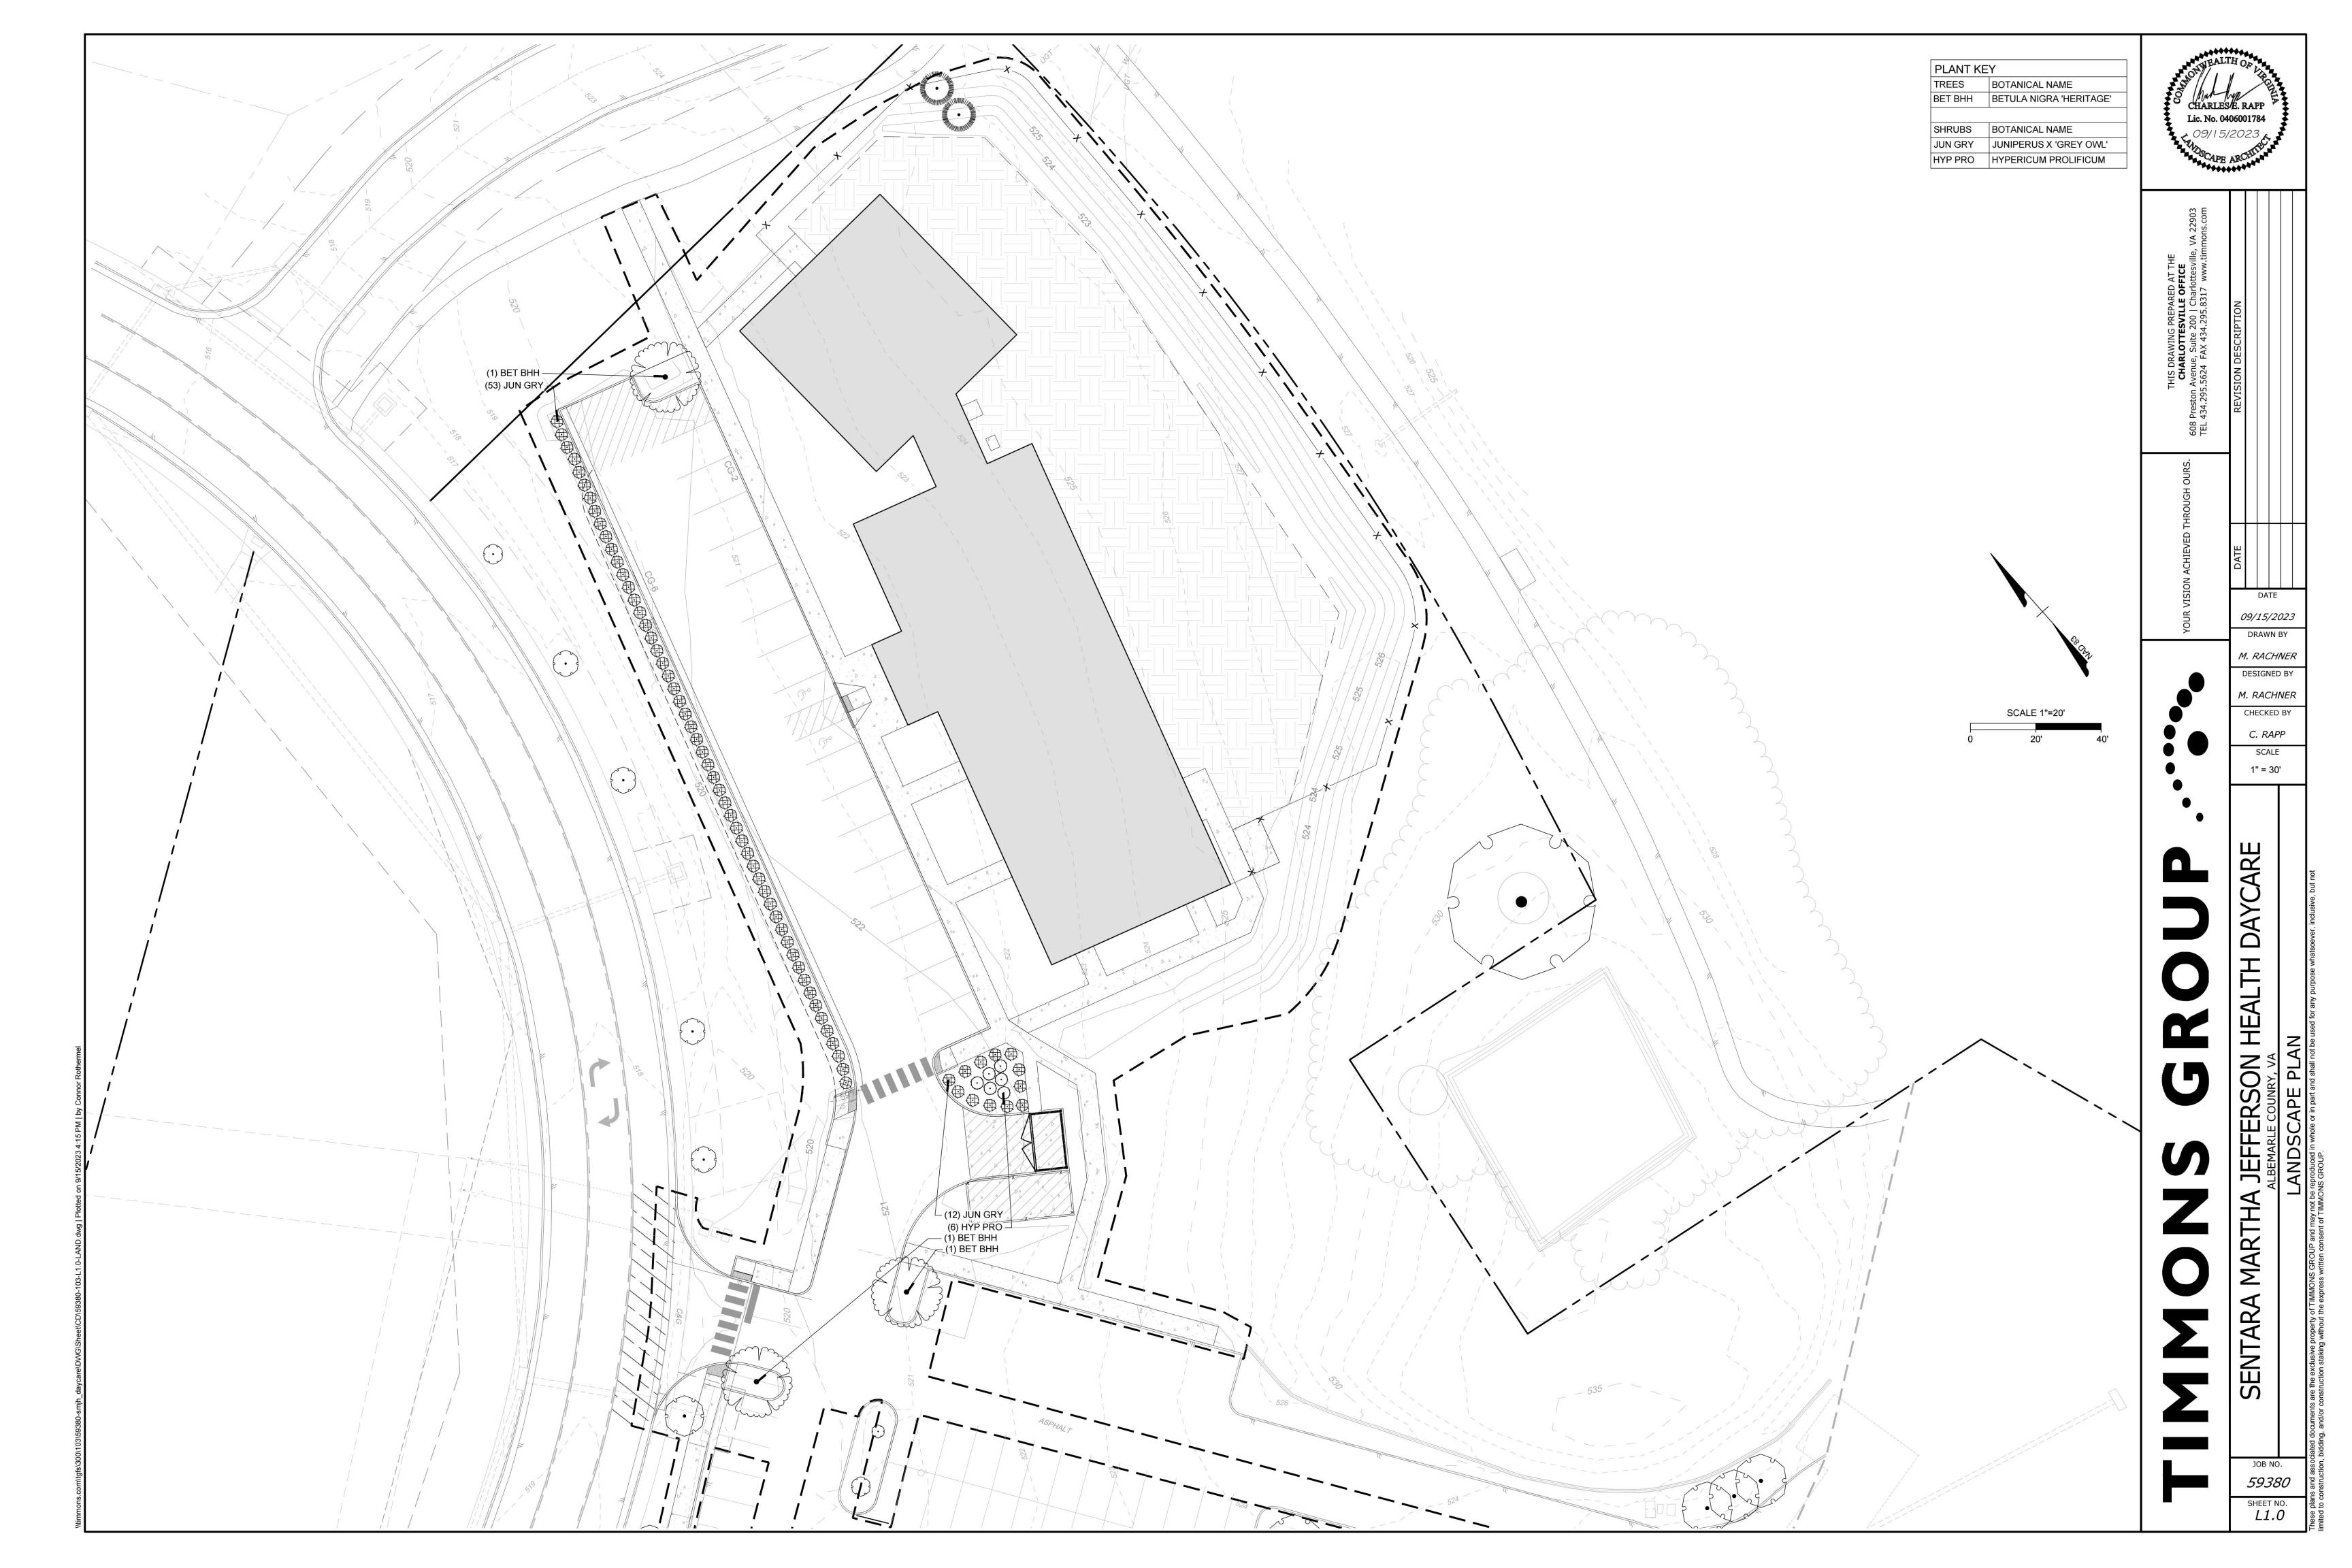

GENERAL NOTES

PRE-CONSTRUCTION

- CONTRACTOR IS RESPONSIBLE FOR CONTACTING "MISS UTILITY" AT 1.800.552.7001 FOR LOCATION OF ALL UTILITY LINES.TREES SHALL BE LOCATED A MINIMUM OF 5 FEET FROM SEWER/WATER CONNECTIONS. NOTIFY LANDSCAPE ARCHITECT OF CONFLICTS.
- VERIFY ALL PLANT MATERIAL QUANTITIES ON THE PLAN PRIOR TO BIDDING, PLANT LIST TOTALS ARE FOR CONVENIENCE ONLY AND SHALL BE VERIFIED PRIOR TO BIDDING.
- PROVIDE PLANT MATERIALS OF QUANTITY, SIZE, GENUS, SPECIES, AND VARIETY INDICATED ON PLANS. ALL PLANT MATERIALS AND INSTALLATION SHALL COMPLY WITH RECOMMENDATIONS AND REQUIREMENTS OF ANSI Z60.1 "AMERICAN STANDARD FOR NURSERY STOCK". IF SPECIFIED PLANT MATERIAL IS NOT OBTAINABLE, SUBMIT PROOF OF NON AVAILABILITY TO THE ARCHITECTS, TOGETHER WITH PROPOSAL FOR USE OF EQUIVALENT MATERIAL.
- PROVIDE AND INSTALL ALL PLANTS AS IN ACCORDANCE WITH DETAILS AND CONTRACT SPECIFICATIONS

CONSTRUCTION/INSTALLATION


- LANDSCAPE ARCHITECT RESERVES THE RIGHT TO REJECT ANY PLANTS AND MATERIALS THAT ARE IN AN UNHEALTHY OR UNSIGHTLY CONDITION, AS WELL AS PLANTS AND MATERIALS THAT DO NOT
- CONFORM TO ANSI Z60.1 "AMERICAN STANDARD FOR NURSERY STOCK" LABEL AT LEAST ONE TREE AND ONE SHRUB OF EACH VARIETY AND CALIPER WITH A SECURELY ATTACHED, WATERPROOF TAG BEARING THE DESIGNATION OF BOTANICAL AND COMMON NAME.
- INSTALL LANDSCAPE PLANTINGS AT ENTRANCES/EXITS AND PARKING AREAS ACCORDING TO PLANS SO THAT MATERIALS WILL NOT INTERFERE WITH SIGHT DISTANCES.
- CONTRACTOR IS RESPONSIBLE FOR WATERING ALL PLANT MATERIAL DURING INSTALLATION AND UNTIL FINAL INSPECTION AND ACCEPTANCE BY OWNER. CONTRACTOR SHALL NOTIFY OWNER OF CONDITIONS WHICH AFFECTS THE GUARANTEE.

INSPECTIONS/GUARANTEE


- UPON COMPLETION OF LANDSCAPE INSTALLATION, THE LANDSCAPE CONTRACTOR SHALL NOTIFY THE GENERAL CONTRACTOR WHO WILL VERIFY COMPLETENESS, INCLUDING THE REPLACEMENT OF ALL DEAD PLANT MATERIAL. CONTRACTOR IS RESPONSIBLE FOR SCHEDULING A FINAL INSPECTION BY THE LANDSCAPE ARCHITECT.
- ALL EXTERIOR PLANT MATERIALS SHALL BE GUARANTEED FOR ONE FULL YEAR AFTER DATE OF FINAL INSPECTION AGAINST DEFECTS INCLUDING DEATH AND UNSATISFACTORY GROWTH. DEFECTS RESULTING FROM NEGLECT BY THE OWNER, ABUSE OR DAMAGE BY OTHERS, OR UNUSUAL PHENOMENA OR INCIDENTS WHICH ARE BEYOND THE CONTRACTORS CONTROL ARE NOT THE RESPONSIBILITY OF THE CONTRACTOR
- PLANT MATERIAL QUANTITIES AND SIZES WILL BE INSPECTED FOR COMPLIANCE WITH APPROVED PLANS BY A SITE PLAN REVIEW AGENT OF THE PLANNING DEPARTMENT PRIOR TO THE RELEASE OF THE CERTIFICATE OF OCCUPANCY.
- REMOVE ALL GUY WIRES AND STAKES 12 MONTHS AFTER INSTALLATION.

MAINTENANCE


 OWNER IS RESPONSIBLE FOR LIFETIME MAINTENANCE AND HEALTH OF REQUIRED LANDSCAPING.

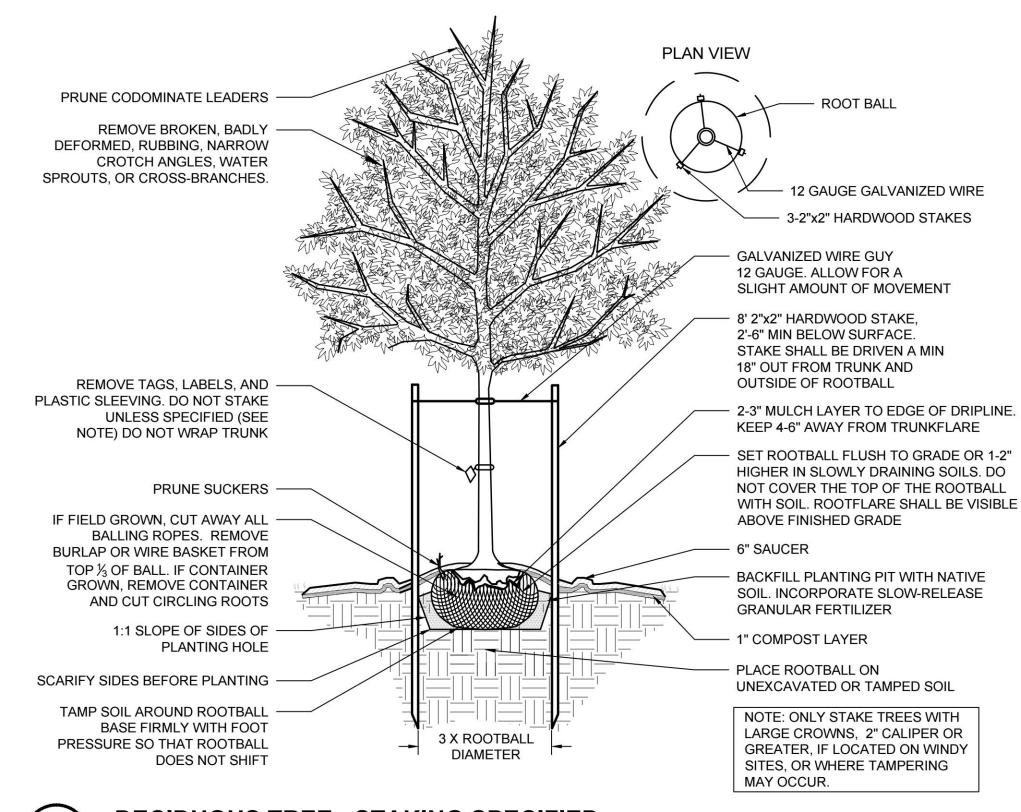


DECIDUOUS TREE - STAKING SPECIFIED

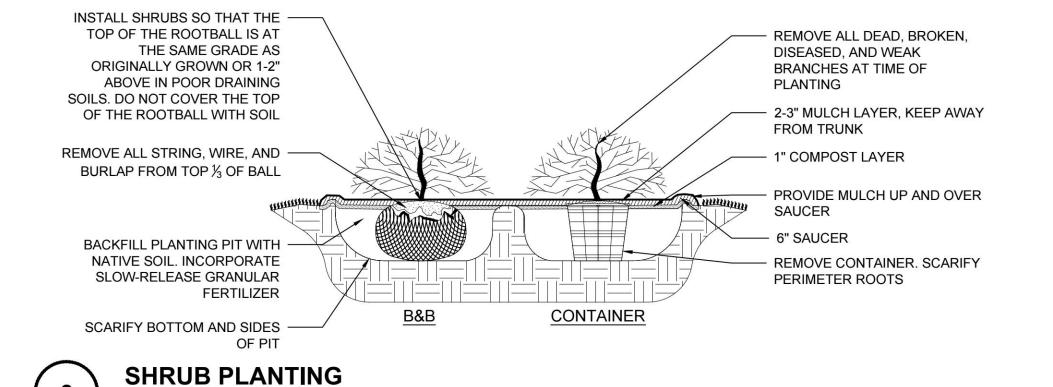



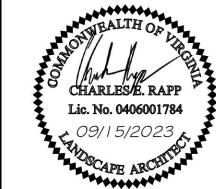

EXISTING TREE SCHEDULE

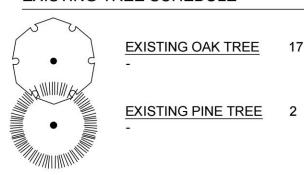

INTERIOR PARKING LOT LANDSCAPE AREA REQUIREMENTS

* per Sec. 32.7.9.6 of the Albemarle County Code

| PARKING LOT | REQUIREMENT | PARKING LOT AREA | CALCULATIONS | REQUIRED | PROVIDED | | | |
|----------------|--------------------------|------------------|----------------------|----------|----------|--|--|--|
| PARKING LOT #1 | 5% GROSS PARKING AREA | 9,378 SF | 9,378 x .05 = 469 SF | 469 SF | 860 SF | | | |

INTERIOR PARKING LOT LANDSCAPING REQUIREMENTS

* ner Sec 32 7 9 6 of the Albemarle County Code

| per Sec. 32.7.9. | 2.7.9.6 of the Albemane County Code | | | | |
|------------------|---|-----------------------|--------------|------------------------------|------------------------|
| PARKING LOT | REQUIREMENT | PARKING LOT SPACES | CALCULATIONS | REQUIRED | PROVIDED |
| PARKING LOT #1 | 1 LG. OR 1 MED. SHADE TREE PER 10 PARKING SPACES | 17 NEW PARKING SPACES | 17/10 = 1.7 | 2 LG. OR MED. SHADE TREES | 3 LARGE SHADE TREES |

TREE COVER CALCULATIONS

* per Sec. 32 7 9 8 of the Albemarle County Code

| per dec. 02.7.3.0 or the Alberharie doubtly doue | | | | | | | | |
|--|-------------|--|-------------------|---|--|--|--|--|
| SITE AREA | REQUIREMENT | CALCULATION | REQUIRED QUANTITY | PROVIDED QUANTITY | | | | |
| 1.95 AC (GROSS SITE AREA) | 10% COVER | 1.95 AC x .1 = .195 AC = 8,494.2 SF | 8,494.2 SF | 7,427 SF(EXISTING) + 1,605 SF (PROPOSED) = 9,032 SF | | | | |

-WHERE A PARKING AREA IS LOCATED SO THAT PARKED CARS ARE VISIBLE FROM AN OFF-SITE STREET, SHRUBS ARE TO BE INSTALLED AT A MINIMUM HEIGHT OF 12".

-ALL SITE PLANTINGS OF TREES AND SHRUBS SHALL BE ALLOWED TO REACH, AND BE MAINTAINED AT, MATURE HEIGHT; THE TOPPING OF TREES IS PROHIBITED. SHRUBS AND TREES SHALL BE PRUNED MINIMALLY AND ONLY TO SUPPORT THE OVERALL HEALTH OF THE PLANT.

THIS DRAWING PREPARE

CHARLOTTESVILLE C
Avenue, Suite 200 | Cha

09/15/2023

DRAWN BY M. RACHNER

DESIGNED BY M. RACHNER CHECKED BY

C. RAPP **SCALE**


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MARTH

59380

SHEET NO. L2.0


NOT TO SCALE

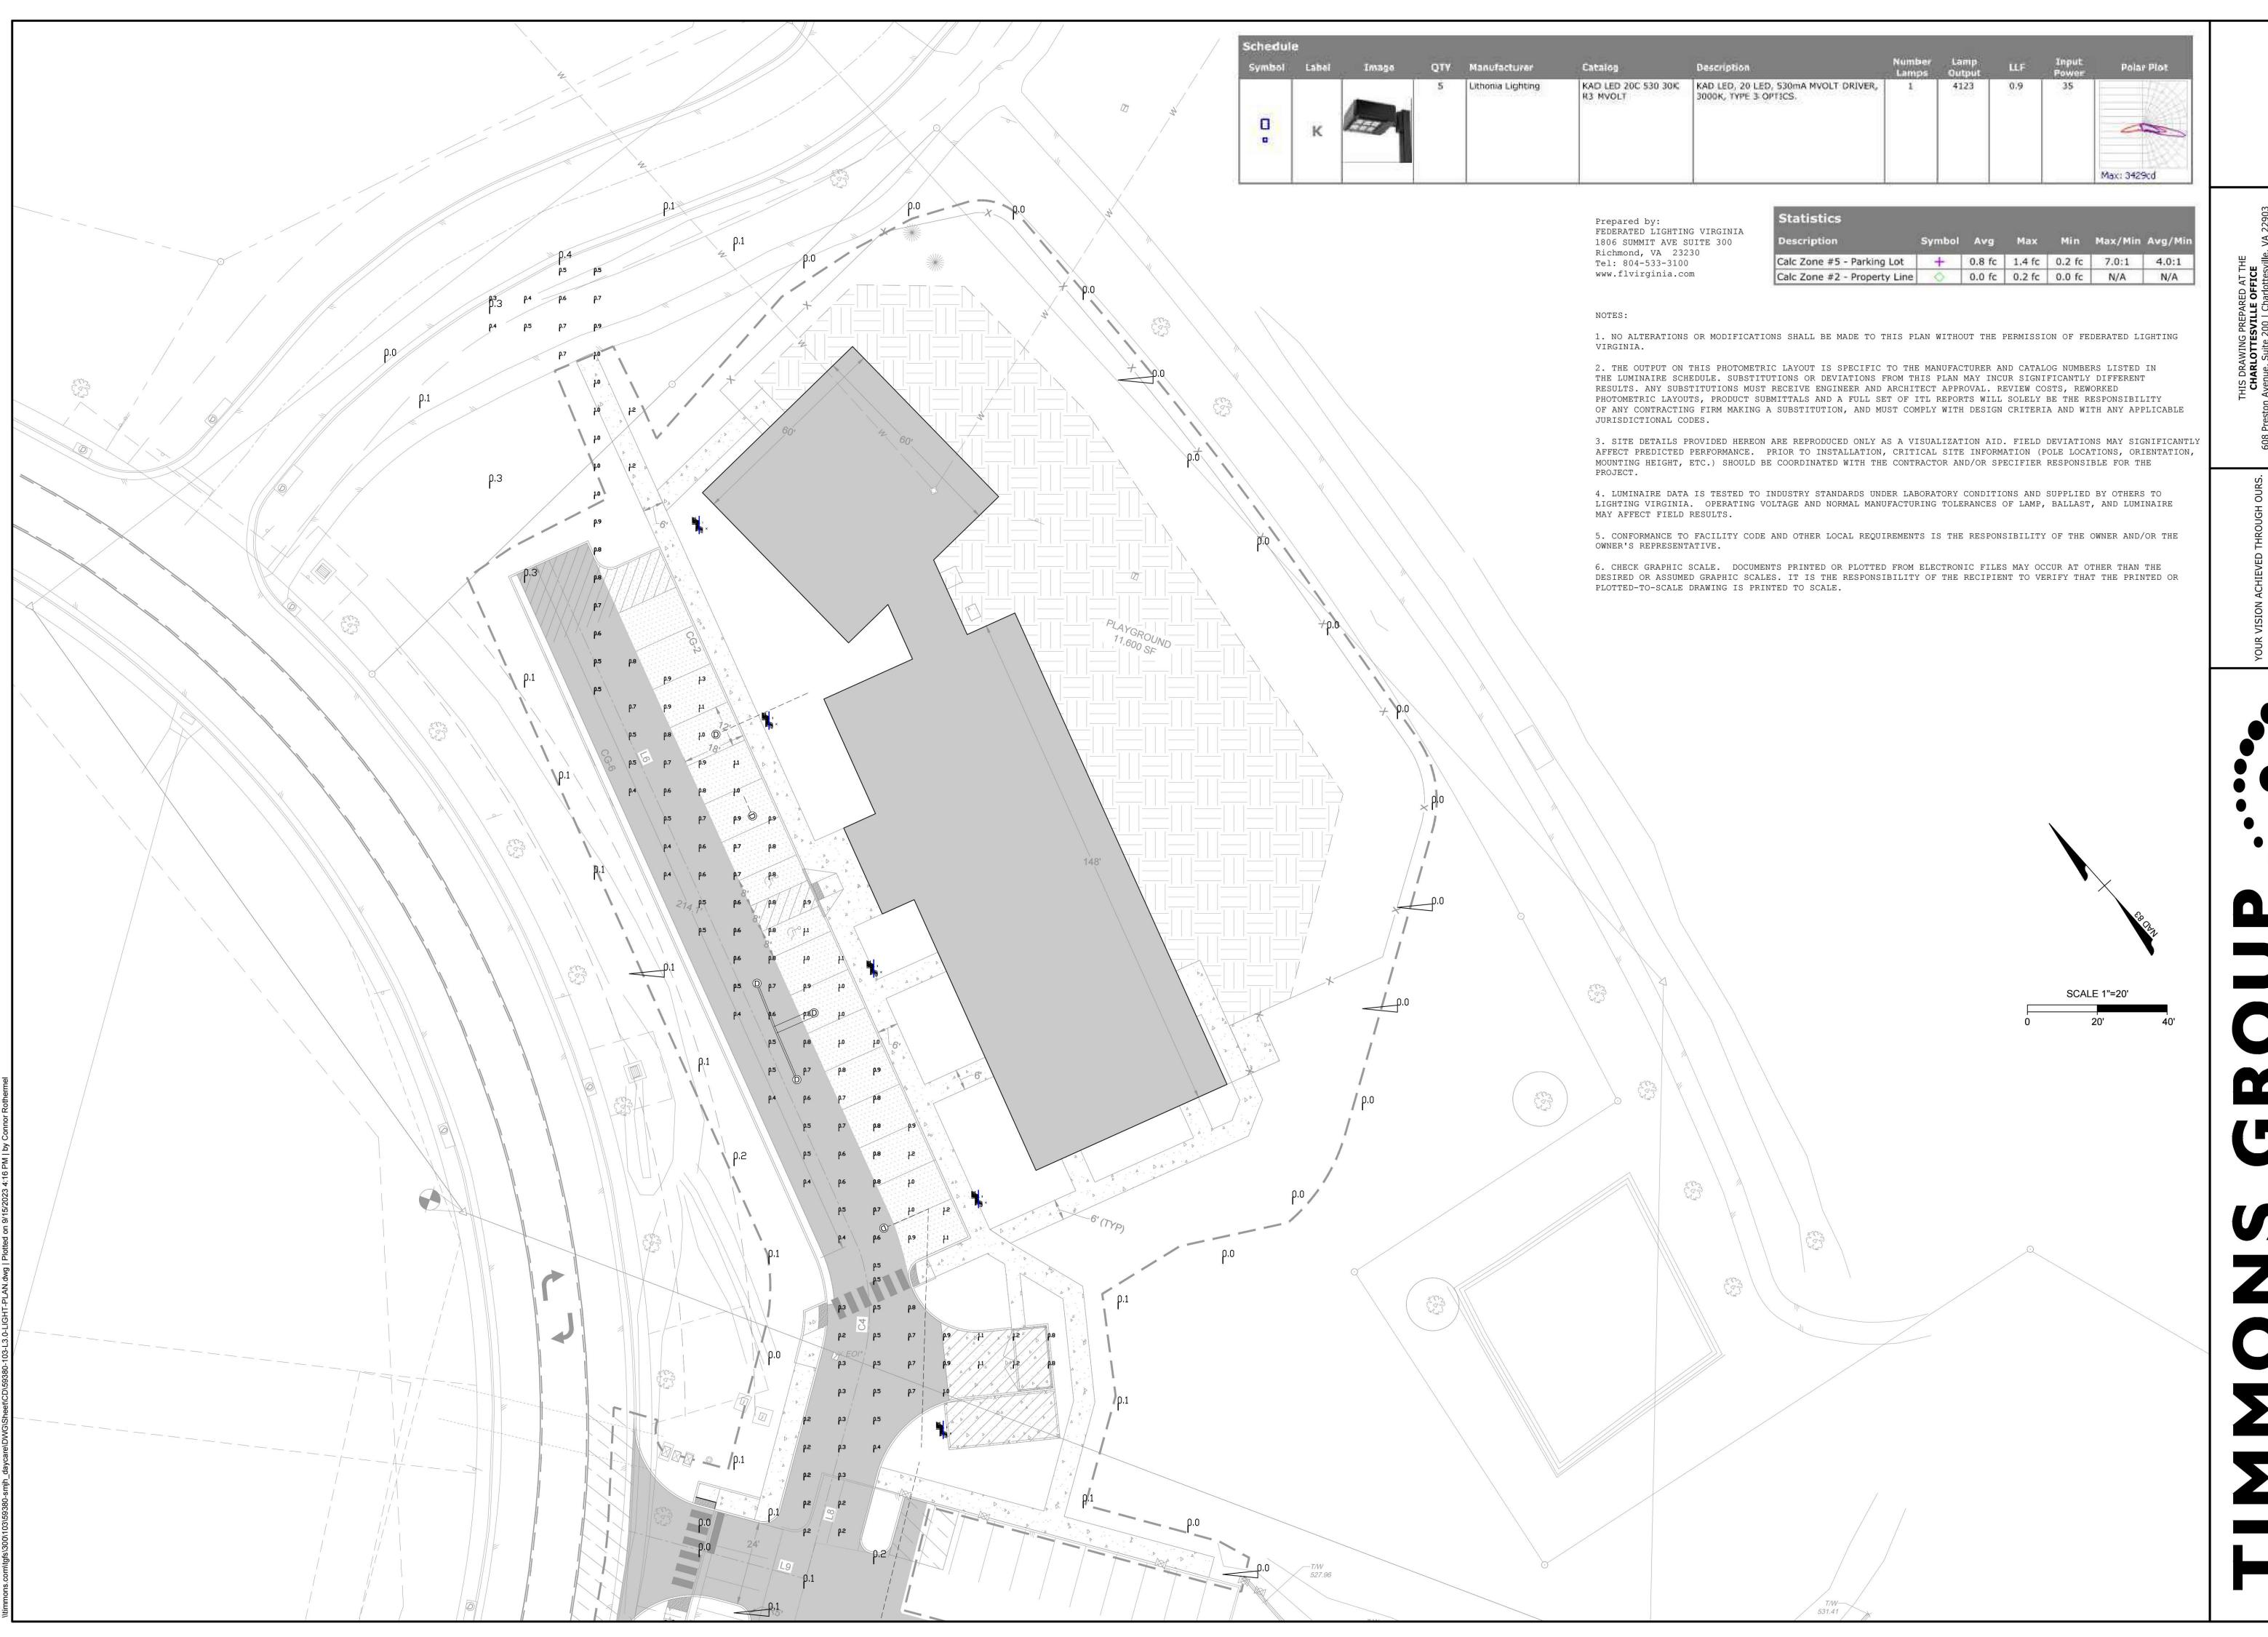

09/15/2023 DRAWN BY M. RACHNER DESIGNED BY

M. RACHNER CHECKED BY C. RAPP

59380 SHEET NO. *L3.0*

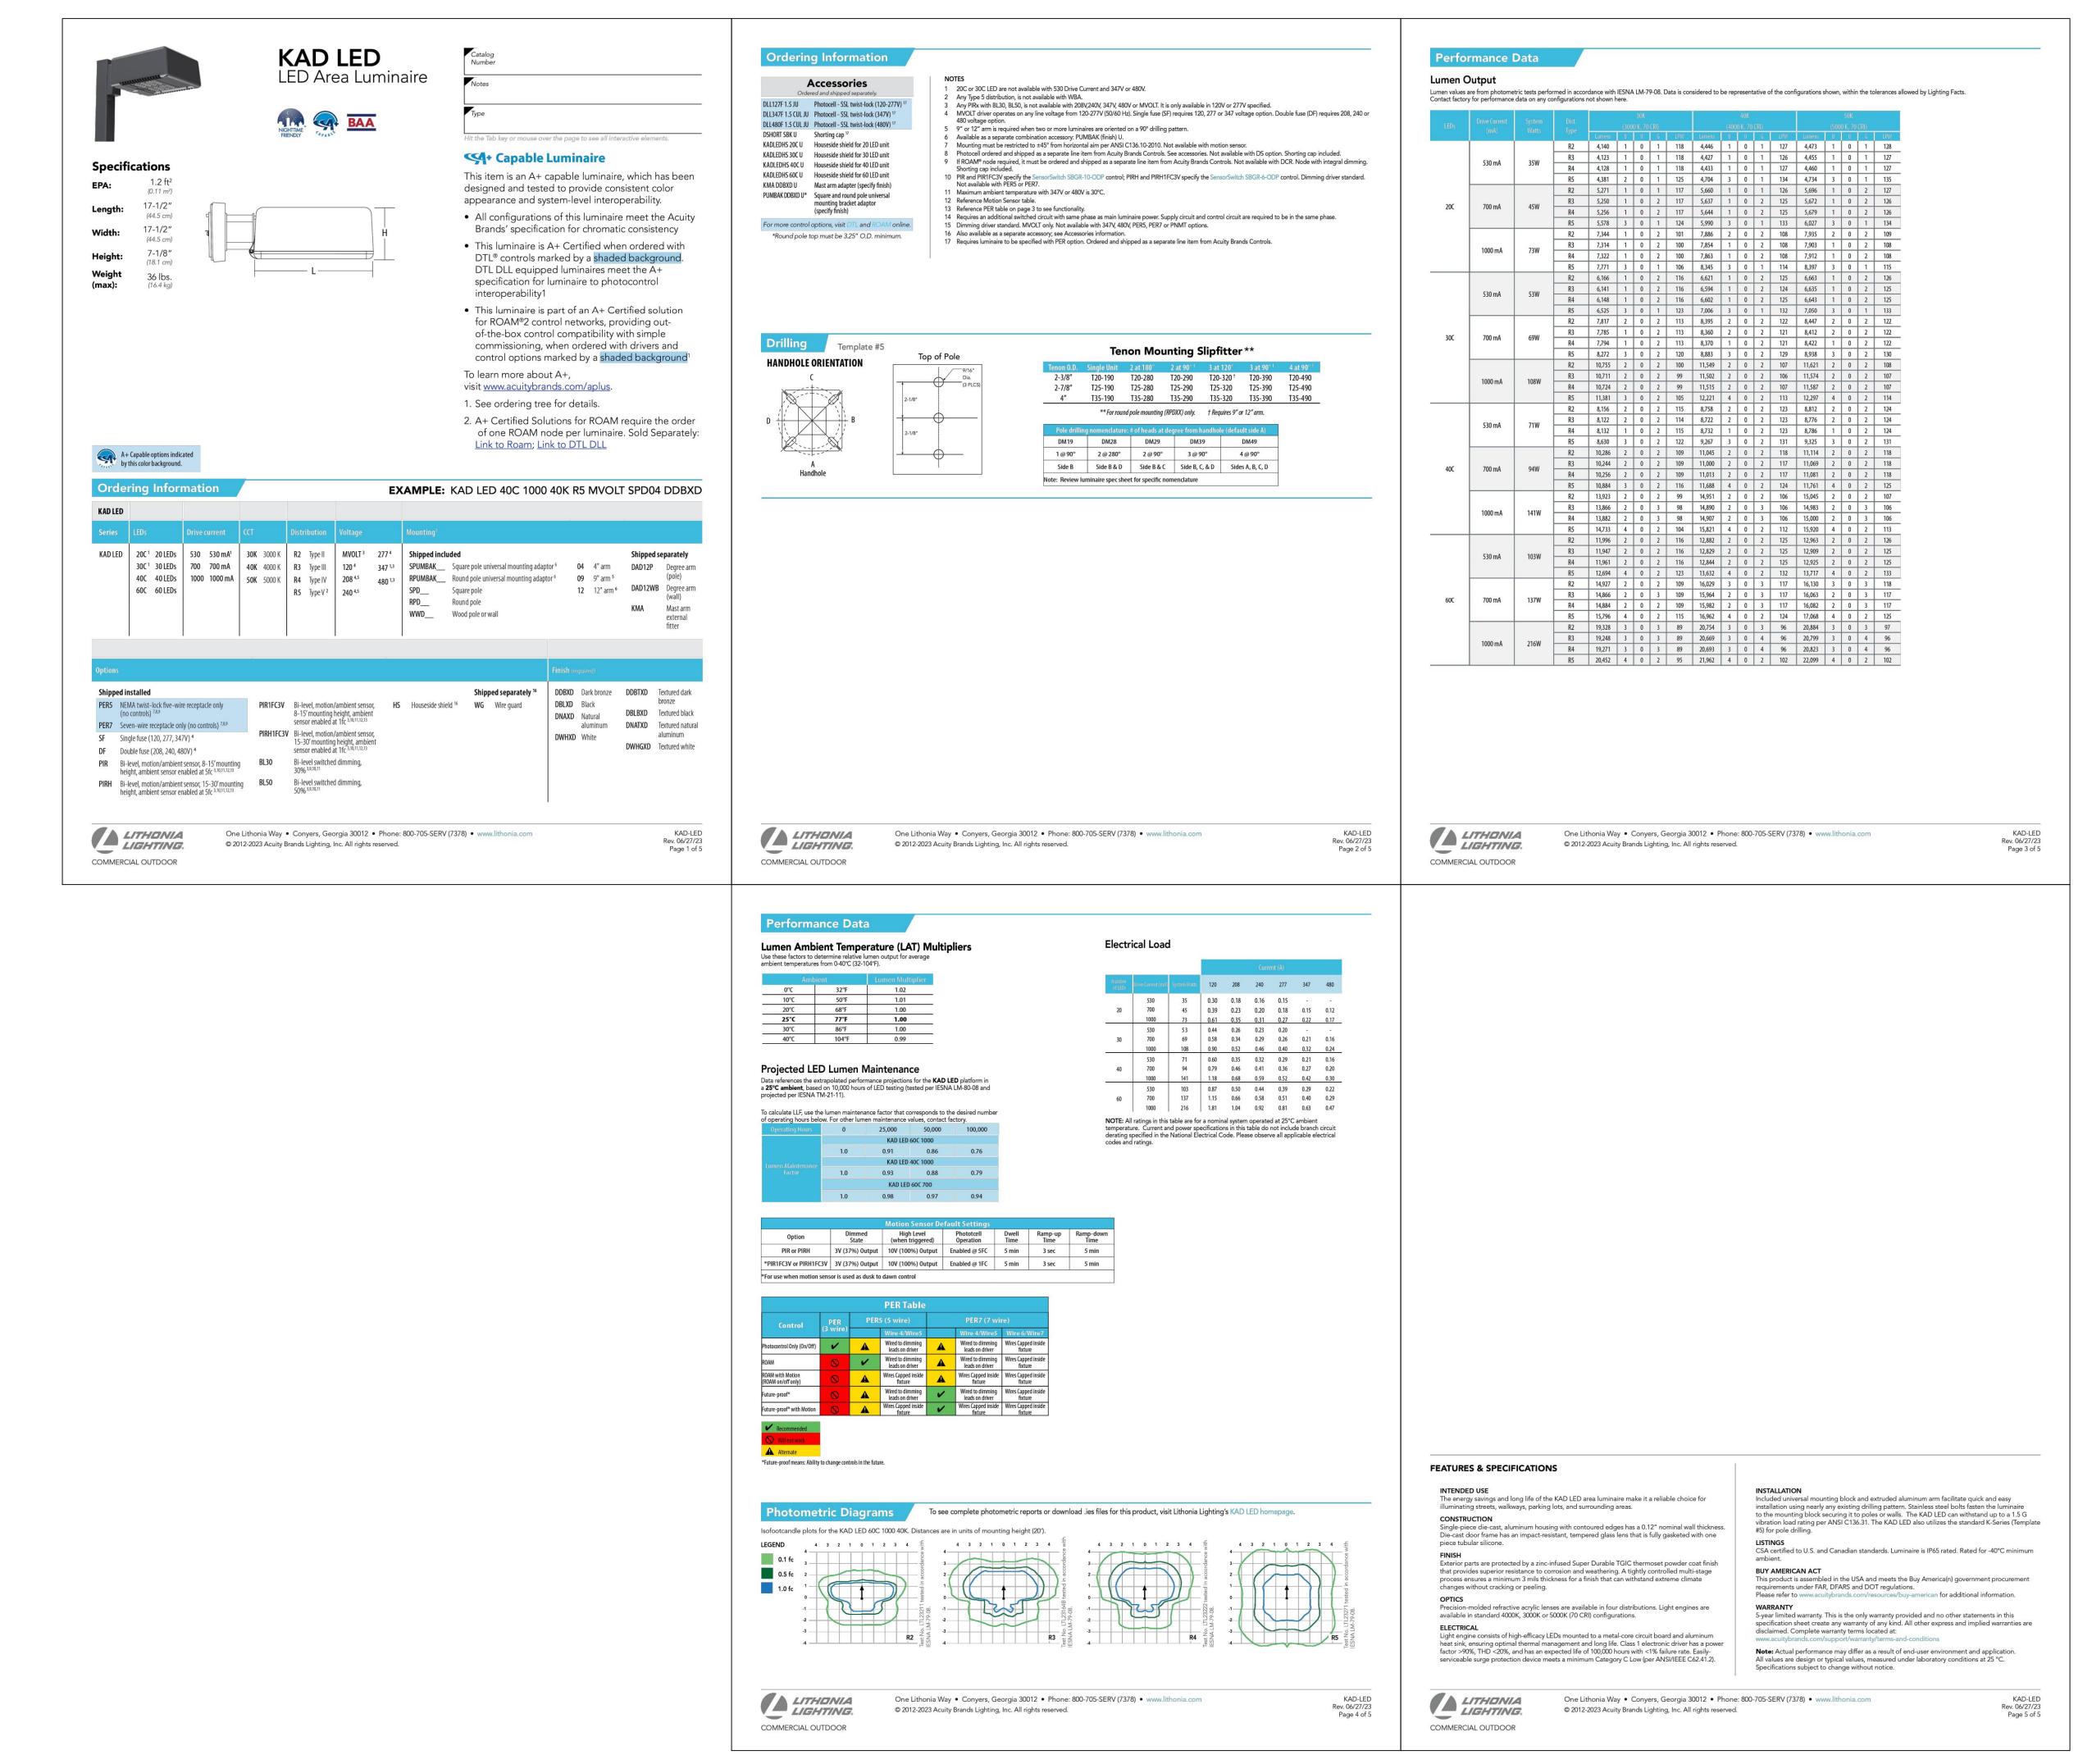

HIS DRAWING PREPARE

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